API NUMBER: 049 25358 OKLAHOMA CORPORATION COMMISSION **OIL & GAS CONSERVATION DIVISION** P.O. BOX 52000 **OKLAHOMA CITY, OK 73152-2000** (Rule 165:10-3-1)

Approval Date: 01/14/2022 07/14/2023 **Expiration Date:**

Special Orders:

Deep surface casing has been approved

No Special

Multi Unit Oil & Gas

d reason: ADD SCMR AND HNTN TO TARGET

RMATIONS; UPDAT			<u> </u>	AMEND) PER	<u>MIT</u>	TO DRILL	<u>.</u>						
WELL LOCATION:	Section:	31 Township:	: 1N Ra	nge: 1W	County: G	SARVIN								
SPOT LOCATION:	NW	NW NW	FEET FROM QUAI	RTER: FROM	NORTH	FROM	WEST							
			SECTION L	INES:	240		885							
Lease Name:	LOWLANDS			Well No:	1-31-32XH	·w		Well will be	240 1	feet from ne	earest unit	or lease b	oundary.	
Operator Name:	CONTINENTAL	RESOURCES INC		Telephone:	405234979	97; 4052	349000;			OTC/0	OCC Numb	oer:	3186 0	
CONTINENT	AL RESOUR	CES INC				EL	EAZAR & KATI	E ROMO						
PO BOX 2688	370					PC	BOX 388							
OKLAHOMA	CITY,	OK	73126-8870)		DA	VIS			OK	73030			
Formation(s)	(Permit Valid	d for Listed For	mations Only):										
Name		Code)	Depth										
1 SYCAMORE		352S	CMR	13288										
2 WOODFORD)	319W	/DFD	13800										
3 HUNTON		269H	INTN	13867										
Spacing Orders:	161935		L	ocation Excep	otion Orders:	: No	Exceptions		Incre	eased Densi	ty Orders:	No D	ensity	

Working interest owners' notified:

Depth to base of Treatable Water-Bearing FM: 340 Surface Casing: 1500 Total Depth: 23961 Ground Elevation: 932

Under Federal Jurisdiction: No Approved Method for disposal of Drilling Fluids: Fresh Water Supply Well Drilled: No D. One time land application -- (REQUIRES PERMIT) PERMIT NO: 21-37770 Surface Water used to Drill: Yes SEE MEMO H. (Other)

PIT 1 INFORMATION Type of Pit System: CLOSED Closed System Means Steel Pits

Type of Mud System: WATER BASED

Chlorides Max: 5000 Average: 3000

715985

202001882

Pending CD Numbers:

Is depth to top of ground water greater than 10ft below base of pit? Y

Within 1 mile of municipal water well? N Wellhead Protection Area? N

located in a Hydrologically Sensitive Area.

Category of Pit: C

Liner not required for Category: C

Pit Location is: BED AQUIFER Pit Location Formation: WELLINGTON

PIT 2 INFORMATION

Type of Pit System: CLOSED Closed System Means Steel Pits

Type of Mud System: OIL BASED Chlorides Max: 300000 Average: 200000

Is depth to top of ground water greater than 10ft below base of pit? Y

Within 1 mile of municipal water well? N

Wellhead Protection Area? N

Pit located in a Hydrologically Sensitive Area. Category of Pit: C

Liner not required for Category: C

Pit Location is: BED AQUIFER Pit Location Formation: WELLINGTON MULTI UNIT HOLE 1

Section: 32 Township: 1N Range: 1W Meridian: IM Total Length: 9755

> County: GARVIN Measured Total Depth: 23961

True Vertical Depth: 15000 Spot Location of End Point: C NE NE NE

> Feet From: NORTH 1/4 Section Line: 330 End Point Location from Lease, Unit, or Property Line: 330 Feet From: EAST 1/4 Section Line: 330

NOTES:	
Category	Description
DEEP SURFACE CASING	[12/16/2021 - GC2] - APPROVED; NOTIFY OCC FIELD INSPECTOR IMMEDIATELY OF ANY LOSS OF CIRCULATION OR FAILURE TO CIRCULATE CEMENT TO SURFACE ON ANY CONDUCTOR OR SURFACE CASING
HYDRAULIC FRACTURING	[12/16/2021 - GC2] - OCC 165:10-3-10 REQUIRES:
	1) NOTICE SHALL BE GIVEN AT LEAST 5 BUSINESS DAYS PRIOR TO COMMENCEMENT OF HYDRAULIC FRACTURING OPERATIONS ON A HORIZONTAL WELL TO OPERATORS PRODUCING WELLS WITHIN 1 MILE OF THE COMPLETION INTERVAL OF THE SUBJECT WELL. THE NOTICE TO SUCH OPERATORS SHALL CONTAIN THE INFORMATION IN FORM 6000NOO. IF THE HYDRAULIC FRACTURING OPERATIONS SCHEDULE CHANGES AFTER NOTICE HAS BEEN PROVIDED, RESULTING IN A DELAY OF OPERATIONS OF MORE THAN 5 DAYS FROM THE INITIAL NOTICE, NEW NOTICE IS REQUIRED TO BE GIVEN;
	2) NOTICE WILL BE GIVEN TO THE OCC CENTRAL OFFICE AND LOCAL DISTRICT OFFICES AT LEAST 48 HOURS PRIOR TO COMMENCEMENT OF HYDRAULIC FRACTURING OPERATIONS. FORM 6000NHF SHALL BE USED AND IS FOUND AT THIS LINK: OCCEWEB.COM/OG/OGFORMS.HTML; AND,
	3) THE CHEMICAL DISCLOSURE OF HYDRAULIC FRACTURING INGREDIENTS FOR ALL WELLS IS TO BE REPORTED TO FRACFOCUS WITHIN 60 DAYS AFTER THE CONCLUSION OF HYDRAULIC FRACTURING OPERATIONS, FOUND AT FRACFOCUS.ORG
МЕМО	[12/16/2021 - GC2] - CLOSED SYSTEM=STEEL PITS PER OPERATOR REQUEST, OBM RETURNED TO VENDOR, CUTTINGS PERMITTED PER DISTRICT
PENDING CD - 202001882	[1/14/2022 - GB6] - (E.O.) 31 & 32 -1N-1W X161935 SCMR, WDFD, HNTN COMPL. INT. (31-1N-1W) NCT 330' FNL, NCT 150' FWL, NCT 0' FEL COMPL. INT. (32-1N-1W) NCT 330' FNL, NCT 0' FWL, NCT 150' FEL NO OPER. NAMED REC. 01/14/2022 (P. PORTER)
SPACING - 161935	[1/3/2022 - GB6] - (640/320/40) 31, 32 -1N-1W (40)(SE4 32-1N-1W) EST OTHERS (320)(E2 32-1N-1W) EST OTHER (640) 31, 32 -1N-1W EST SCMR, WDFD, HNTN, OTHERS
SPACING - 715985 (202001883)	[1/3/2022 - GB6] - (I.O.) 31 & 32 -1N-1W EST MULTIUNIT HORIZONTAL WELL X161935 SCMR, WDFD, HNTN (SCMR, HNTN ADJACENT COMMON SOURCES OF SUPPLY TO WDFD) 50% 31-1N-1W 50% 32-1N-1W CONTINENTAL RESOURCES, INC. 12/17/2020

EXHIBIT: <u>A (1 of 2)</u> SHEET: 8.5x11 SHL: 31-1N-1W BHL-1: 32-1N-1W



WELL PAD ID: F336A97A-5395-E978-3150-31856E0D79E1

SH-1-ID: Q4TJR0014A

COVER SHEET

<u>CONTINENTAL</u> <u>RESOURCES</u>, <u>INC</u>. P.O. BOX 26900 OKLAHOMA CITY, OK 73126 * (T) 1-800-256-8955 (F) 405-234-9253

Section 31 Township 1N Range 1W I.M. SH-1: LOWLANDS 1-31-32XHW

County ____State __OK___

Operator _____CONTINENTAL RESOURCES, INC.

		NAD	-83					
POINT	WELL NAME	NORTHING	EASTING	LATITUDE LONGITUDE	LATITUDE LONGITUDE		EXISTING ELEVATION	DESIGN ELEVATION
SH-1	LOWLANDS 1-31-32XHW	432747	2164403	34° 31' 14.60" -97° 20' 58.66"	34.520723 -97.349627	240' FNL / 885' FWL (NW/4 NE/4 NW/4 NW/4 SEC 31)	932.40'	932.29'
LP-1	LANDING POINT	432657	2164403	34° 31′ 13.71″ -97° 20′ 58.66″	34.520476 -97.349627	330' FNL / 885' FWL (NW/4 SEC 31)		
BHL-1	BOTTOM HOLE LOCATION	432710	2173764	34° 31' 13.63" -97° 19' 06.78"	34.520452 -97.318551	330' FNL / 330' FEL (NE/4 SEC 32)		
X-1	MORTON CAROL A #1-31	431349	2167156	34° 31′ 00.61″ -97° 20′ 25.86″	34.516835 -97.340515	31-1N-1W: TD: 16610' 1653' FNL / 1655' FEL		
X-2	PETTY #1	430042	2169812	34° 30′ 47.50″ -97° 19′ 54.23″	34.513194 -97.331730	32-1N-1W: TD: 3280' 2310' FSL / 990' FWL		
X-3	MORROW #1	429400	2172793	34° 30′ 40.96″ -97° 19′ 18.66″	34.511377 -97.321849	32-1N-1W: TD: 3280' 1650' FSL / 1329' FEL		

		NAD-	-27					
POINT	WELL NAME	NORTHING	EASTING	LATITUDE LONGITUDE	LATITUDE LONGITUDE		EXISTING ELEVATION	DESIGN ELEVATION
SH-1	LOWLANDS 1-31-32XHW	432704	2195998	34° 31′ 14.30″ -97° 20′ 57.57″	34.520639 -97.349326	240' FNL / 885' FWL (NW/4 NE/4 NW/4 NW/4 SEC 31)	932.40'	932.29'
LP-1	LANDING POINT	432614	2195999	34° 31′ 13.41″ -97° 20′ 57.57″	34.520392 -97.349326	330' FNL / 885' FWL (NW/4 SEC 31)		
BHL-1	BOTTOM HOLE LOCATION	432667	2205359	34° 31′ 13.32″ -97° 19′ 05.70″	34.520367 -97.318251	330' FNL / 330' FEL (NE/4 SEC 32)		
X-1	MORTON CAROL A #1-31	431307	2198752	34° 31′ 00.30″ -97° 20′ 24.77″	34.516750 -97.340215	31-1N-1W: TD: 16610' 1653' FNL / 1655' FEL		
X-2	PETTY #1	429999	2201407	34° 30′ 47.19″ -97° 19′ 53.14″	34.513109 -97.331429	32-1N-1W: TD: 3280' 2310' FSL / 990' FWL		
X-3	MORROW #1	429358	2204388	34° 30′ 40.65″ -97° 19′ 17.57″	34.511292 -97.321548	32-1N-1W: TD: 3280' 1650' FSL / 1329' FEL		

Certificate of Authorization No. 7318



Prepared By: PSLS 14612 Hertz Quail Springs Pkwy. Oklahoma City, OK 73134

	REVISIONS							
	No.	DATE	STAKED	BY	DESCRIPTION	COMMENTS		
	00	11-19-21	11-23-21	HDG	ISSUED FOR APPROVAL			
,								

EXHIBIT: <u>A (2 of 2)</u>


8.5x14 SHFFT: 31 - 1N - 1WSHL: <u>32</u>-1N-1W BHL-1:

PETRO LAND SERVICES SOUTH, LL 14612 HERTZ QUAIL SPRINGS PKWY, OKLA. CITY, OKLA. 73134 * OFFICE (405) 212-3108 Certificate of Authorization No. 7318



CONTINENTAL RESOURCES, INC (OPERATOR)

GARVIN _ County Oklahoma 240' FNL-885' FWL Section 31 <u>1N</u> Range ___1W _ Township

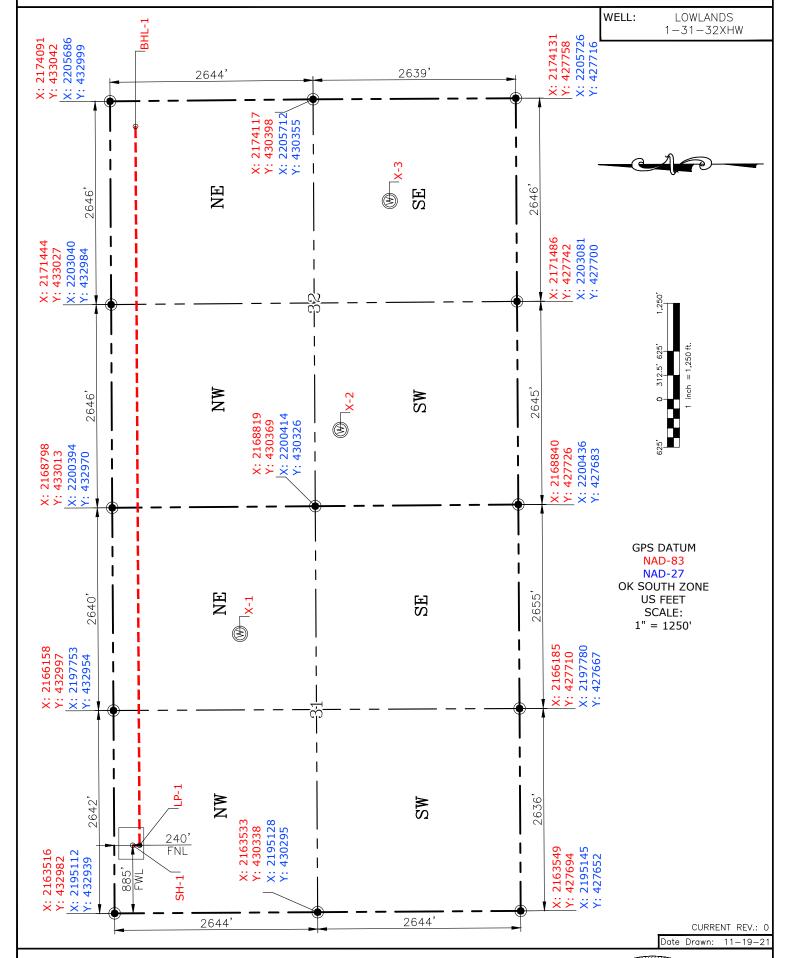

Please note that this location was staked on the ground under the supervision of a Licensed Professional Land Surveyor, but the accuracy of this survey is not guaranteed. Please contact PLS promptly if any inconsistency is determined. GPS data is observed from RTK-GPS. NOTE: X and Y data shown hereon for Section Corners may NOT have been surveyed on-the-ground, and further, does NOT represent a true Boundary Survey. Quarter Section distances may be assumed from a Government Survey Plat or assumed at a proportionate distance from opposing section corners, or occupation thereof, and may not have been measured on-the-ground, and further, does not represent a true Boundary Survey.

CERTIFICATE:

I, FRED A. SELENSKY, an Oklahoma Licensed Land Surveyor and an authorized agent of Petro Land Services South, LLC, do hereby certify to the information shown herein.

IONAZ Fred A. Selensky 1860 OKL AHOMP

//-19-21 Oklahoma PLS No.1860 DATE

EXHIBIT: _____B

SHEET: 8.5×11


SHL: $\frac{31-1N-1W}{32-1N-1W}$


PETRO LAND SERVICES SOUTH, LLC

14612 HERTZ QUAIL SPRINGS PKWY, OKLA. CITY, OKLA. 73134 * OFFICE (405) 212-3108 Certificate of Authorization No. 7318



CONTINENTAL RESOURCES,INC (OPERATOR)

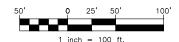

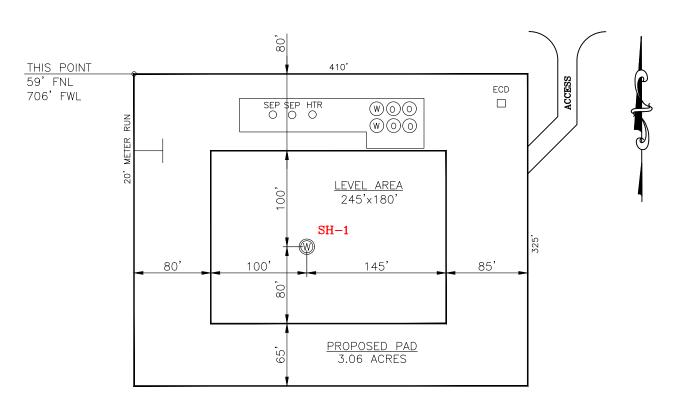

CURRENT REV.: 0

SH-1: LOWLANDS 1-31-32XHW

DATUM: NAD-83

NORTHING: 432747

EASTING: 2164403

LAT: <u>N34°31'14.60"</u>

LONG: W97°20'58.66"

LAT: 34.520723°

LONG: -97.349627°

STATE PLANE COORDINATES

(US FEET): SOUTH

This Information Was Gathered With a GPS Receiver With ±1 Foot Horiz./Vert. Accuracy

Operator: CONTINENTAL RESOURCES, INC.

Lease Name: ____

Topography & Vegetation: Pasture

Good Drill Site? Yes Reference Stakes or Alternate Location Stakes Set: No

Best Accessibility to Location: From The North Line

Distance & Direction From Hwy. or Town: Leaving Hennepin, head north on Katie Road for 0.87 miles & turn right on E-1720 Rd. Head east for 0.22 miles to the

proposed access road.

THE INFORMATION SHOWN HEREIN IS FOR CONSTRUCTION PURPOSES ONLY

LANDING POINT, BOTTOM HOLE AND DRILL PATH INFORMATION PROVIDED BY OPERATOR LISTED, NOT SURVEYED.

Well SH-1: LOWLANDS 1-31-32XHW

Certificate of Authorization No. 7318

Prepared By:




PSLS 14612 Hertz Quail Springs Pkwy. Oklahoma City, OK 73134 EXHIBIT: _____C


SHEET: 8.5×11

SHL: $\frac{31-1N-1W}{32-1N-1W}$



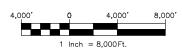

VICINITY MAP

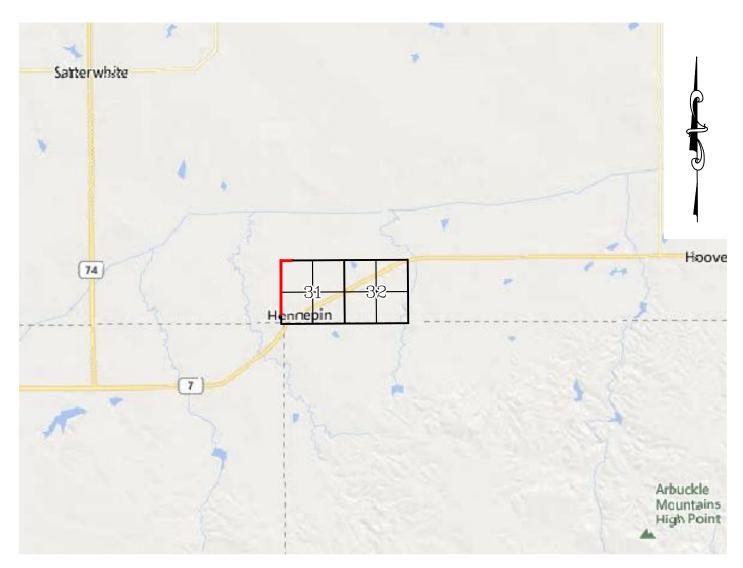

LEAVING HENNEPIN, HEAD NORTH ON KATIE ROAD FOR 0.87 MILES & TURN RIGHT ON E-1720 RD. HEAD EAST FOR 0.22 MILES TO THE PROPOSED ACCESS ROAD.

CONTINENTAL RESOURCES, INC.

P.O. BOX 26900 OKLAHOMA CITY, OK 73126 * (T) 1-800-256-8955 (F) 405-234-9253

$\overline{}$	
5L	5

Prepared By: Petro Land Services South 14612 Hertz Quail Springs Pkwy. Oklahoma City, OK 73134

Section	31	Township	1N	Range	1 W	I.M.	Well SH-1:	LOWLANDS	1-31-32XHW

County ____State OK

Operator _____CONTINENTAL RESOURCES, INC.

Well SH-1: LOWLANDS 1-31-32XHW

EXHIBIT: _____D

SHEET: 8.5x11

SHL: $\frac{31-1N-1W}{32-1N-1W}$



FACING NORTH



FACING SOUTH



CURRENT REV.: 0

Prepared By:



TERRAIN

DRAWN BY:	HDG	SCALE:	N.T.S.
CHECKED BY:	MJL	JOB No.:	
APPROVED BY:		DWG. NO.:	TERRAIN-1
DATE ISSUED:	11-19-21	SHEET:	1 OF 2

Well SH-1: LOWLANDS 1-31-32XHW

EXHIBIT: ____E

SHEET: 8.5x11

SHL: $\frac{31-1N-1W}{32-1N-1W}$



FACING EAST



FACING WEST



CURRENT REV.: 0

Prepared By:



TERRAIN

DRAWN BY:	HDG	SCALE:	N.T.S.
CHECKED BY:	MJL	JOB No.:	
APPROVED BY:		DWG. NO.:	TERRAIN-2
DATE ISSUED:	11-19-21	SHEET:	2 OF 2


EXHIBIT: ____F

SHEET: 8.5x11
SHL: 31-1N-1W

BHL-1: 32-1N-1W



PROPOSED ACCESS ROAD = 159' | 9.64 RODS (TOTAL)

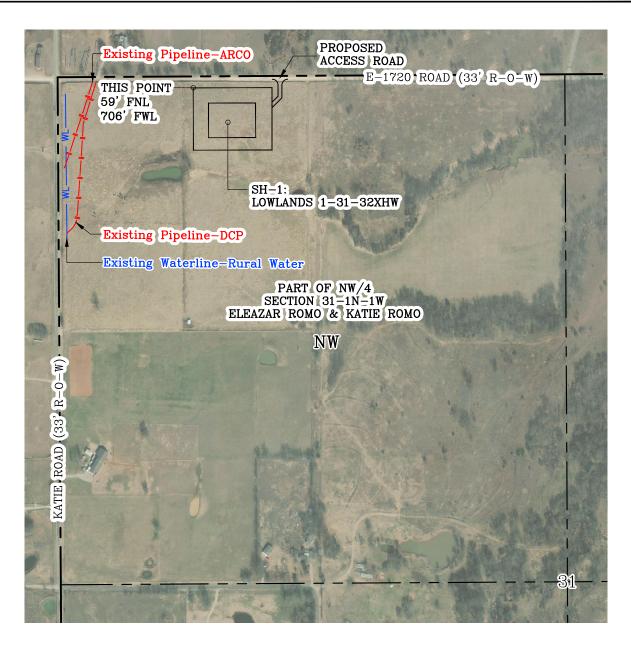

Section 31 Township 1N Range 1W I.M.

County GARVIN State OK

Operator CONTINENTAL RESOURCES, INC.



CURRENT REV.: 0

Prepared



PSLS 14612 Hertz Quail Springs Pkwy. Oklahoma City, OK 73134 AERIAL PLAT

DRAWN BY:	HDG	SCALE:	1" = 500'
CHECKED BY:	MJL	JOB No.:	
APPROVED BY:		DWG. NO.:	AERIAL-1
DATE ISSUED:	11-19-21	SHEET:	1 OF 4

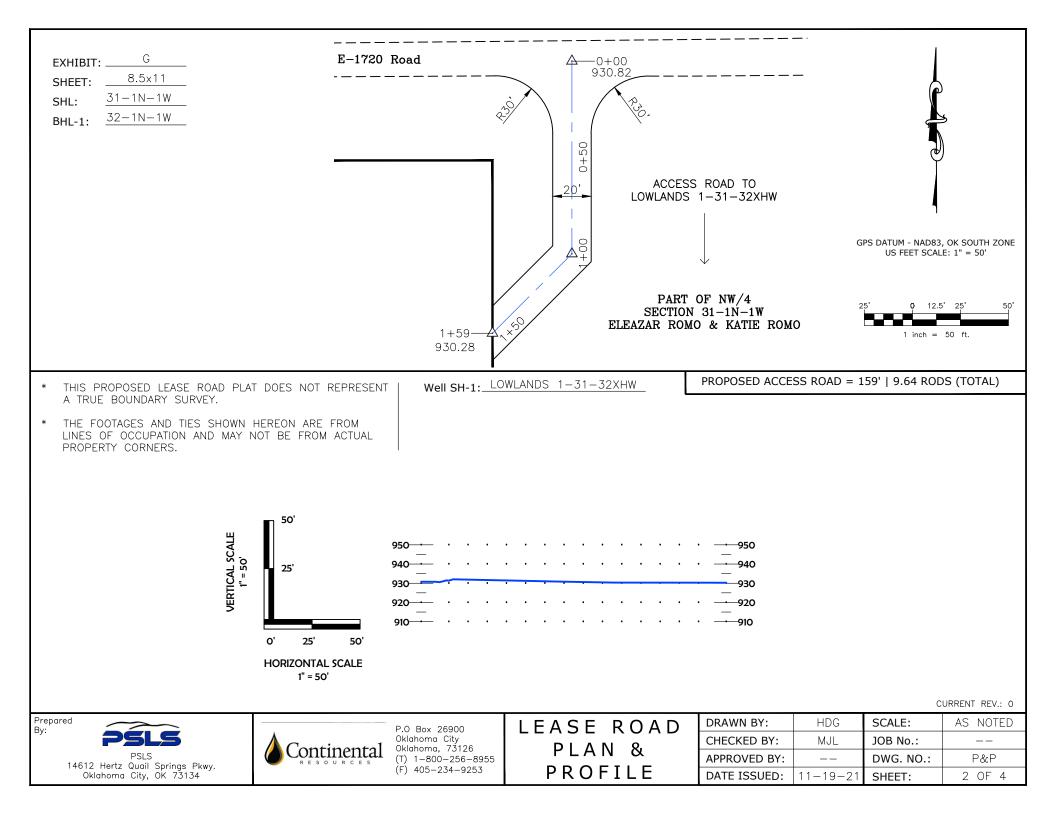



EXHIBIT: ____H

SHEET: 8.5x11

SHL: $\frac{31-1N-1W}{32-1N-1W}$



Well SH-1: LOWLANDS 1-31-32XHW

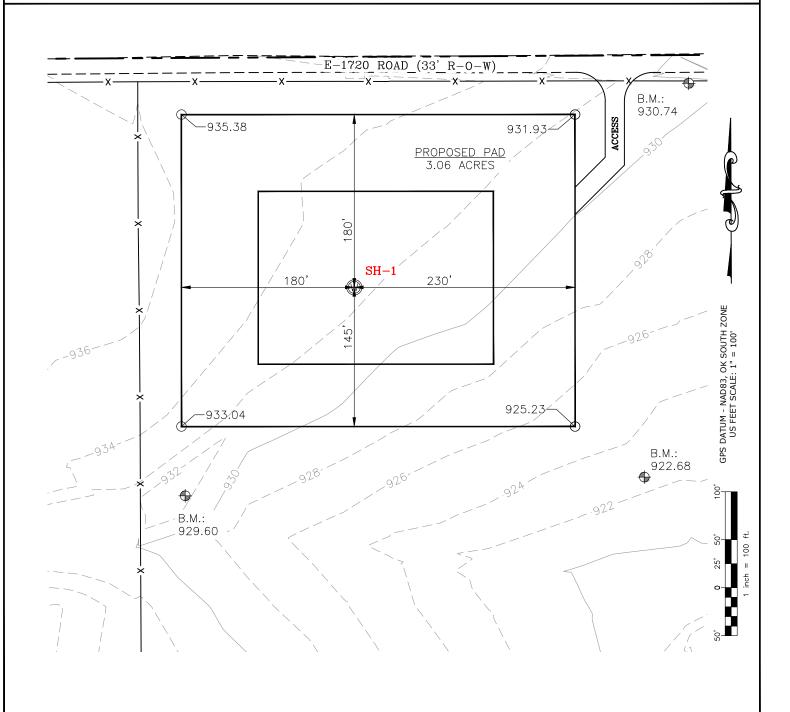

CURRENT REV.: 0

Prepared By:



PSLS 14612 Hertz Quail Springs Pkwy. Oklahoma City, OK 73134 EXISTING GRADING PLAN

DRAWN BY:	HDG	SCALE:	1" = 100'
CHECKED BY:	MJL	JOB No.:	
APPROVED BY:		DWG. NO.:	EX-GR.
DATE ISSUED:	11-19-21	SHEET:	3 OF 4


EXHIBIT: _____

SHEET: 8.5x11

SHL: $\frac{31-1N-1W}{32-1N-1W}$



TOTAL PROPOSED DISTURBED AREA: 3.92 ACRES

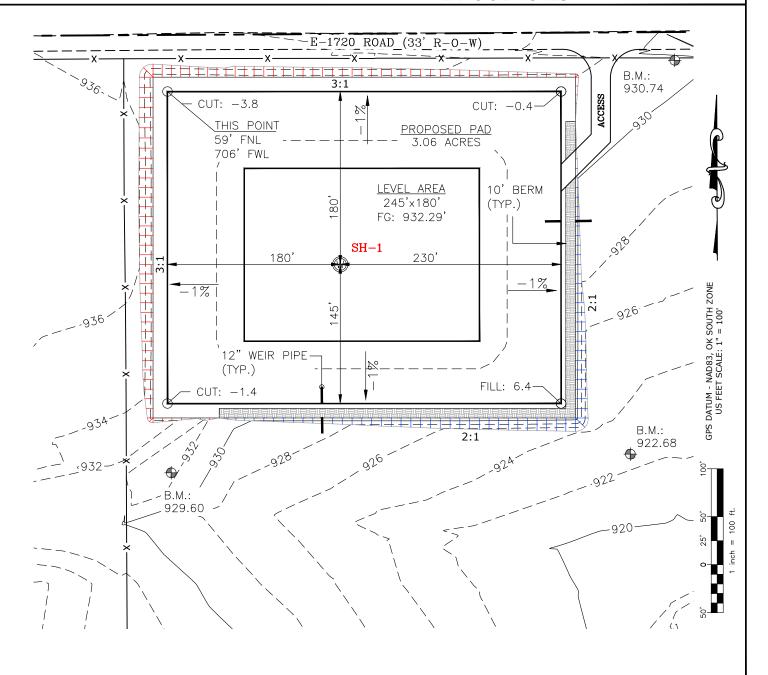

CUT VOLUME 5192.87 CU. YD. | 6" OF STRIPPED TOP SOIL: 3,159.11 CU. YD. FILL VOLUME 5193.49 CU. YD. | BERM LENGTH: 642' (430.14 CU. YD.)

(CUT/FILL VOLUMES DO NOT INCLUDE 6" OF STRIPPED TOP SOIL)

CURRENT REV.: 0

Prepared Bv:



PSLS 14612 Hertz Quail Springs Pkwy. Oklahoma City, OK 73134 PROPOSED GRADING PLAN

DRAWN BY:	HDG	SCALE:	1" = 100'
CHECKED BY:	MJL	JOB No.:	
APPROVED BY:		DWG. NO.:	PRO-GR.
DATE ISSUED:	11-19-21	SHEET:	4 OF 4

EXHIBIT "A"


TABLE OF QUANTITIES

DISTURBED AREA = 3.92 ACRES ACCESS ROAD = ± 159 '

LOCATED ON THE LANDS OF: ELEAZAR ROMO & KATIE ROMO

PART OF NW/4 SEC 31-1N-1W GARVIN COUNTY, OKLAHOMA



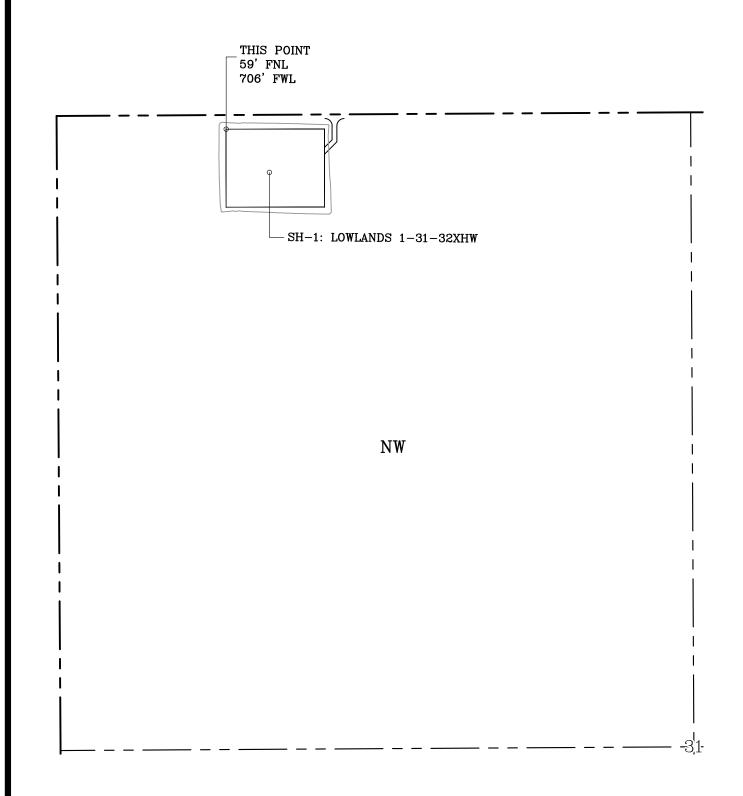

GENERAL NOTES:

- 1. THIS IS NOT A BOUNDARY SURVEY.
- 2. THIS SURVEY DOES NOT GUARANTEE TITLE OR OWNERSHIP.

