API NUMBER: 011 24304

OKLAHOMA CORPORATION COMMISSION OIL & GAS CONSERVATION DIVISION P.O. BOX 52000 OKLAHOMA CITY, OK 73152-2000 (Rule 165:10-3-1)

Approval Date: 02/03/2022
Expiration Date: 08/03/2023

Multi Unit Oil & Gas

### **PERMIT TO DRILL**

WELL LOCATION: Section: 06 Township: 14N Range: 13W County: BL	AINE		
SPOT LOCATION: NE NE NW NE FEET FROM QUARTER: FROM NORTH	FROM EAST		
SECTION LINES: 315	1385		
Lease Name: B PERKINS Well No: 3-6-7-18XH	M Well will be 315 feet from nearest unit or lease boundary.		
Operator Name: CONTINENTAL RESOURCES INC Telephone: 4052349797	7; 4052349000; OTC/OCC Number: 3186 0		
CONTINENTAL RESOURCES INC	SCOTT PERKINS FARMS LLC		
PO BOX 268870	C/O BRAD PERKINS		
OKLAHOMA CITY, OK 73126-8870	90560 N 2450 ROAD		
	THOMAS OK 73669		
	70000		
Formation(s) (Permit Valid for Listed Formations Only):			
Name Code Depth			
1 MISSISSIPPIAN (LESS CHESTER) 359MSNLC 12802			
2 MISSISSIPPIAN 359MSSP 12821			
Spacing Orders: 668480 Location Exception Orders:	No Exceptions Increased Density Orders: No Density		
665202			
664508			
Pending CD Numbers: 202200263 Working interest owners	notified: *** Special Orders: No Special		
202200264			
202200265			
202200266			
202200267			
Total Depth: 27937 Ground Elevation: 1547 Surface Casing: 1	500 Depth to base of Treatable Water-Bearing FM: 60		
Goding Elevation. 1647 Currace Guaring.			
	Deep surface casing has been approved		
Under Federal Jurisdiction: No	Approved Method for disposal of Drilling Fluids:		
Fresh Water Supply Well Drilled: No	D. One time land application (REQUIRES PERMIT) PERMIT NO: 21-38009		
Surface Water used to Drill: Yes	H. (Other) SEE MEMO		
PIT 1 INFORMATION	Category of Pit: C		
Type of Pit System: CLOSED Closed System Means Steel Pits	Liner not required for Category: C		
Type of Mud System: WATER BASED	Pit Location is: NON HSA		
Chlorides Max: 8000 Average: 5000	Pit Location Formation: DOG CREEK		
Is depth to top of ground water greater than 10ft below base of pit? Y			
Within 1 mile of municipal water well? N			
Wellhead Protection Area? N			
Pit <u>is not</u> located in a Hydrologically Sensitive Area.			
PIT 2 INFORMATION	Category of Pit: C		
Type of Pit System: CLOSED Closed System Means Steel Pits	Liner not required for Category: C		
Type of Mud System: OIL BASED	Pit Location is: NON HSA		
Chlorides Max: 300000 Average: 200000	Pit Location Formation: DOG CREEK		
Is depth to top of ground water greater than 10ft below base of pit? Y			
Within 1 mile of municipal water well? N			
Wellhead Protection Area? N			
Pit <u>is not</u> located in a Hydrologically Sensitive Area.			

**MULTI UNIT HOLE 1** 

Section: 18 Township: 14N Range: 13W Meridian: IM Total Length: 14883

County: BLAINE Measured Total Depth: 27937

Spot Location of End Point: SE SE SW SE True Vertical Depth: 13451

Feet From: SOUTH 1/4 Section Line: 50 End Point Location from
Feet From: EAST 1/4 Section Line: 1495 Lease,Unit, or Property Line: 50

NOTES:

Category	Description
DEEP SURFACE CASING	[2/2/2022 - GC2] - APPROVED; NOTIFY OCC FIELD INSPECTOR IMMEDIATELY OF ANY LOSS OF CIRCULATION OR FAILURE TO CIRCULATE CEMENT TO SURFACE ON ANY CONDUCTOR OR SURFACE CASING
HYDRAULIC FRACTURING	[2/2/2022 - GC2] - OCC 165:10-3-10 REQUIRES:
	1) NOTICE SHALL BE GIVEN AT LEAST 5 BUSINESS DAYS PRIOR TO COMMENCEMENT OF HYDRAULIC FRACTURING OPERATIONS ON A HORIZONTAL WELL TO OPERATORS PRODUCING WELLS WITHIN 1 MILE OF THE COMPLETION INTERVAL OF THE SUBJECT WELL. THE NOTICE TO SUCH OPERATORS SHALL CONTAIN THE INFORMATION IN FORM 6000NOO. IF THE HYDRAULIC FRACTURING OPERATIONS SCHEDULE CHANGES AFTER NOTICE HAS BEEN PROVIDED, RESULTING IN A DELAY OF OPERATIONS OF MORE THAN 5 DAYS FROM THE INITIAL NOTICE, NEW NOTICE IS REQUIRED TO BE GIVEN;
	2) NOTICE WILL BE GIVEN TO THE OCC CENTRAL OFFICE AND LOCAL DISTRICT OFFICES AT LEAST 48 HOURS PRIOR TO COMMENCEMENT OF HYDRAULIC FRACTURING OPERATIONS. FORM 6000NHF SHALL BE USED AND IS FOUND AT THIS LINK: OCCEWEB.COM/OG/OGFORMS.HTML; AND,
	3) THE CHEMICAL DISCLOSURE OF HYDRAULIC FRACTURING INGREDIENTS FOR ALL WELLS IS TO BE REPORTED TO FRACFOCUS WITHIN 60 DAYS AFTER THE CONCLUSION OF HYDRAULIC FRACTURING OPERATIONS, FOUND AT FRACFOCUS.ORG
INTERMEDIATE CASING	[2/2/2022 - GC2] - DUE TO THE KNOWN POTENTIAL RISK OF ENCOUNTERING AN OVER- PRESSURED ZONE IN THE MORROW SERIES IN THIS AREA, THE TECHNICAL MANAGER RECOMMENDS SETTING AN INTERMEDIATE STRING OF CASING IMMEDIATELY ABOVE THE MORROW SERIES
MEMO	[2/2/2022 - GC2] - CLOSED SYSTEM=STEEL PITS (REQUIRED - CANADIAN RIVER), OBM RETURNED TO VENDOR, CUTTINGS PERMITTED PER DISTRICT
PENDING CD - 202200263	[2/3/2022 - G56] - (E.O.) 6, 7 & 18-14N-13W X668480 MSNLC 6-14N-13W X665202 MSSP 7-14N-13W X664508 MSSP 18-14N-13W COMPL INT (6-14N-13W) NCT 150' FNL, NCT 0' FSL, NCT 990' FWL COMPL INT (7-14N-13W) NCT 0' FNL, NCT 0' FSL, NCT 1320' FEL COMPL INT (18-14N-13W) NCT 0' FNL, NCT 150' FSL, NCT 1320' FEL NO OP NAMED REC 2/1/2022 (MILLER)
PENDING CD - 202200264	[2/3/2022 - G56] - (E.O.) 6, 7 & 18-14N-13W EST MULTIUNIT HORIZONTAL WELL X668480 MSNLC 6-14N-13W X665202 MSSP 7-14N-13W X664508 MSSP 18-14N-13W 33% 6-14N-13W 34% 7-14N-13W NO OP NAMED REC 2/1/2022 (MILLER)
PENDING CD - 202200265	[2/3/2022 - G56] - (E.O.) 6-14N-13W X668480 MSNLC 1 WELL NO OP NAMED REC 2/1/2022 (MILLER)
PENDING CD - 202200266	[2/3/2022 - G56] - (E.O.) 7-14N-13W X665202 MSSP 2 WELLS NO OP NAMED REC 2/1/2022 (MILLER)
PENDING CD - 202200267	[2/3/2022 - G56] - (E.O.) 18-14N-13W X664508 MSSP 1 WELL NO OP NAMED REC 2/1/2022 (MILLER)
SPACING - 664508	[2/3/2022 - G56] - (640) 18-14N-13W VAC 94272 MSCST EST MSSP, OTHER
SPACING - 665202	[2/3/2022 - G56] - (640) 7-14N-13W VAC 94272 MSCST EST MSSP, OTHER
SPACING - 668480	[2/3/2022 - G56] - (640)(HOR) 6-14N-13W EXT OTHER EST MSNLC COMPL INT NLT 660' FB

This permit does not address the right of entry or settlement of surface damages. The duration of this permit is 18 MONTHS, except as otherwise provided by Rule 165: 10-3-1. Rule 165: 10-3-4 (c) (7) (e) - The Operator shall give 24 Hours notice by telephone to the appropriate District Office of the Conservation Division as to when Surface Casing will be run.

**EXHIBIT**: <u>A (1 of 3)</u> SHEET: 8.5x11 SHL: <u>6-1</u>4N-13W BHL-3: 18-14N-13W



WELL PAD ID: 2041FC3C-0687-4E5D-4FB2-90D25E140381

SH-3-ID: T5IFMTVDH6

## COVER SHEET

# CONTINENTAL RESOURCES, INC. P.O. BOX 26900 OKLAHOMA CITY, OK 73126 \* (T) 1-800-256-8955 (F) 405-234-9253

Section 6 Township 14N Range 13W I.M. SH-3: B PERKINS 3-6-7-18XHM

County \_\_\_\_\_State \_\_\_OK

Operator \_\_\_\_\_CONTINENTAL RESOURCES, INC.

		NAD-	-83					
POINT	WELL NAME	NORTHING	EASTING	LATITUDE LONGITUDE	LATITUDE LONGITUDE		EXISTING ELEVATION	DESIGN ELEVATION
SH-3	B PERKINS 3-6-7-18XHM	264265	1784726	35° 43′ 27.69″ -98° 37′ 08.86″	35.724359 -98.619126	315' FNL / 1385' FEL (NE/4 NE/4 NW/4 NE/4 SEC 6)	1547.21	1549.59
LP-3	LANDING POINT	264266	1784616	35° 43′ 27.69″ -98° 37′ 10.19″	35.724358 -98.619497	315' FNL / 1495' FEL (NE/4 SEC 6)		
BHL-3	BOTTOM HOLE LOCATION	248867	1784500	35° 40′ 55.40″ -98° 37′ 10.40″	35.682055 -98.619556	50' FSL / 1495' FEL (SE/4 SEC 18)		
X-1	LAPEL #1-6	259974	1781515	35° 42' 45.05" -98° 37' 47.45"	35.712513 -98.629848	6-14N-13W:   TD: 10387'   660' FSL / 660' FWL		
X-2	RENEE #1-6	260629	1784783	35* 42' 51.74" -98* 37' 07.88"	35.714372 -98.618855	6-14N-13W:   TD: 10550'   1320' FSL / 1299' FEL		
X-3	LLOYD SCOTT #1	263096	1782134	35° 43' 15.96" -98° 37' 40.20"	35.721101 -98.627832	6-14N-13W:   TD: 11931'   1494' FNL / 1245' FWL		
X-4	SCOTT #1-6	263934	1781888	35° 43′ 24.23″ -98° 37′ 43.25″	35.723397 -98.628679	6-14N-13W:   TD: 11900'   658' FNL / 990' FWL		
X-5	LAPEL #1	263928	1784796	35° 43′ 24.36″ -98° 37′ 07.97″	35.723434 -98.618881	6-14N-13W:   TD: 11550'   652' FNL / 1312' FEL		
X-6	EDDIE #1-17	258008	1782158	35° 42′ 25.64″ -98° 37′ 39.51″	35.707123 -98.627641	7-14N-13W:   TD: 10610'   1306' FNL / 1320' FWL		
X-7	PERKINS #1	254721	1781770	35° 41′ 53.12″ -98° 37′ 43.95″	35.698088 -98.628874	7-14N-13W:   TD: 10650'   660' FSL / 959' FWL		
X-8	PERKINS #2	255381	1784737	35° 41′ 59.83″ -98° 37′ 08.03″	35.699953 -98.618896	7-14N-13W:   TD: 11870'   1320' FSL / 1304' FEL		
X-9	NICHOLS #1	258007	1784894	35° 42′ 25.81″ -98° 37′ 06.33″	35.707170 -98.618424	7-14N-13W:   TD: 11930'   1302' FNL / 1167' FEL		
X-10	B PERKINS #1-7-18XH	259034	1781426	35° 42' 35.75" -98° 37' 48.46"	35.709930 -98.630129	7-14N-13W:   TD: 23933'   280' FNL / 580' FWL		
X-11	AUSTIN FANSLER # 3-18	252229	1783863	35° 41' 28.60" -98° 37' 18.38"	35.691278 -98.621774	18-14N-13W:   TD: 10600'   1832' FNL / 2155' FEL		
X-12	SWITZER, BEULAH #3-18	251208	1782103	35° 41′ 18.39″ -98° 37′ 39.63″	35.688442 -98.627676	18-14N-13W:   TD: 11000'   2390' FSL / 1320' FWL		
X-13	BEULAH SWITZER #1	250138	1782095	35° 41′ 07.81″ -98° 37′ 39.65″	35.685503 -98.627681	18-14N-13W:   TD: 10699'   1320' FSL / 1320' FWL		
X-14	BEULAH SWITZER #4-18	253420	1781791	35* 41' 40.25" -98* 37' 43.59"	35.694514 -98.628776	18-14N-13W:   TD: 11000'   641' FNL / 990' FWL		
X-15	BEULAH SWITZER #2	252260	1782112	35° 41' 28.80" -98° 37' 39.61"	35.691333 -98.627671	18-14N-13W:   TD: 10620'   1801' FNL / 1320' FWL		

Certificate of Authorization No. 7318



R E	REVISIONS						
No.	DATE	STAKED	BY	DESCRIPTION	COMMENTS		
00	01-13-22	**-**-22	HDG	ISSUED FOR APPROVAL			

**EXHIBIT**: <u>A (2 of 3)</u> SHEET: 8.5x11 SHL: \_6-14N-13W BHL-3: 18-14N-13W



WELL PAD ID: 2041FC3C-0687-4E5D-4FB2-90D25E140381

SH-3-ID: T5IFMTVDH6

## COVER SHEET CONTINUED...

# CONTINENTAL RESOURCES, INC. P.O. BOX 26900 OKLAHOMA CITY, OK 73126 \* (T) 1-800-256-8955 (F) 405-234-9253

Section 6 Township 14N Range 13W I.M. SH-3: B PERKINS 3-6-7-18XHM

County \_\_\_\_\_State \_\_\_OK

Operator \_\_\_\_\_CONTINENTAL RESOURCES, INC.

		NAD-	-27					
POINT	WELL NAME	NORTHING	EASTING	LATITUDE LONGITUDE	LATITUDE LONGITUDE		EXISTING ELEVATION	DESIGN ELEVATION
SH-3	B PERKINS 3-6-7-18XHM	264240	1816327	35° 43' 27.52" -98° 37' 07.57"	35.724311 -98.618771	315' FNL / 1385' FEL (NE/4 NE/4 NW/4 NE/4 SEC 6)	1547.21'	1549.59
LP-3	LANDING POINT	264240	1816217	35° 43' 27.51" -98° 37' 08.91"	35.724310 -98.619141	315' FNL / 1495' FEL (NE/4 SEC 6)		
BHL-3	BOTTOM HOLE LOCATION	248842	1816100	35° 40' 55.22" -98° 37' 09.13"	35.682006 -98.619202	50' FSL / 1495' FEL (SE/4 SEC 18)		
X-1	LAPEL #1-6	259949	1813116	35° 42′ 44.87″ -98° 37′ 46.17″	35.712465 -98.629492	6-14N-13W:   TD: 10387'   660' FSL / 660' FWL		
X-2	RENEE #1-6	260604	1816384	35° 42′ 51.56″ -98° 37′ 06.60″	35.714323 -98.618500	6-14N-13W:   TD: 10550'   1320' FSL / 1299' FEL		
X-3	LLOYD SCOTT #1	263071	1813735	35° 43′ 15.79″ -98° 37′ 38.91″	35.721053 -98.627476	6-14N-13W:   TD: 11931'   1494' FNL / 1245' FWL		
X-4	SCOTT #1-6	263908	1813489	35° 43′ 24.06″ -98° 37′ 41.96″	35.723349 -98.628323	6-14N-13W:   TD: 11900'   658' FNL / 990' FWL		
X-5	LAPEL #1	263903	1816397	35° 43′ 24.19″ -98° 37′ 06.69″	35.723386 -98.618525	6-14N-13W:   TD: 11550'   652' FNL / 1312' FEL		
X-6	EDDIE #1-17	257983	1813759	35° 42' 25.47" -98° 37' 38.23"	35.707075 -98.627286	7-14N-13W:   TD: 10610'   1306' FNL / 1320' FWL		
X-7	PERKINS #1	254696	1813371	35° 41' 52.94" -98° 37' 42.67"	35.698039 -98.628519	7-14N-13W:   TD: 10650'   660' FSL / 959' FWL		
X-8	PERKINS #2	255356	1816338	35° 41' 59.65" -98° 37' 06.75"	35.699904 -98.618541	7-14N-13W:   TD: 11870'   1320' FSL / 1304' FEL		
X-9	NICHOLS #1	257982	1816495	35° 42′ 25.64″ -98° 37′ 05.05″	35.707122 -98.618069	7-14N-13W:   TD: 11930'   1302' FNL / 1167' FEL		
X-10	B PERKINS #1-7-18XH	259009	1813027	35° 42' 35.57" -98° 37' 47.18"	35.709881 -98.629773	7-14N-13W:   TD: 23933'   280' FNL / 580' FWL		
X-11	AUSTIN FANSLER # 3-18	252204	1815464	35° 41' 28.43" -98° 37' 17.11"	35.691229 -98.621419	18-14N-13W:   TD: 10600'   1832' FNL / 2155' FEL		
X-12	SWITZER, BEULAH #3-18	251183	1813704	35° 41′ 18.22″ -98° 37′ 38.36″	35.688394 -98.627321	18-14N-13W:   TD: 11000'   2390' FSL / 1320' FWL		
X-13	BEULAH SWITZER #1	250113	1813696	35° 41' 07.63" -98° 37' 38.38"	35.685454 -98.627326	18-14N-13W:   TD: 10699'   1320' FSL / 1320' FWL		
X-14	BEULAH SWITZER #4-18	253395	1813392	35° 41' 40.07" -98° 37' 42.32"	35.694465 -98.628421	18-14N-13W:   TD: 11000'   641' FNL / 990' FWL		
X-15	BEULAH SWITZER #2	252235	1813713	35° 41' 28.62" -98° 37' 38.34"	35.691284 -98.627316	18-14N-13W:   TD: 10620'   1801' FNL / 1320' FWL		

Certificate of Authorization No. 7318



Prepared By: **PSLS** 14612 Bogert Parkway Oklahoma City, OK 73134

#### PETRO LAND SERVICES SOUTH, LLC

14612 BOGERT PARKWAY, OKLA. CITY, OKLA. 73134 \* OFFICE (405) 212-3108

**Continental** 

CONTINENTAL RESOURCES,INC (OPERATOR)

EXHIBIT: A (3 of 3)


SHEET: 8.5x14

SHL: 6-14N-13W

BHL-3: 18-14N-13W

 $\frac{\text{BLAINE}}{315' \text{ FNL}-1385' \text{ FEL}} \underbrace{\text{Section}}_{\text{6}} \underbrace{\text{Township}}_{\text{14N}} \underbrace{\text{Range}}_{\text{13W}} \underbrace{\text{1.M.}}_{\text{1.M.}}$ 

WELL: B PERKINS

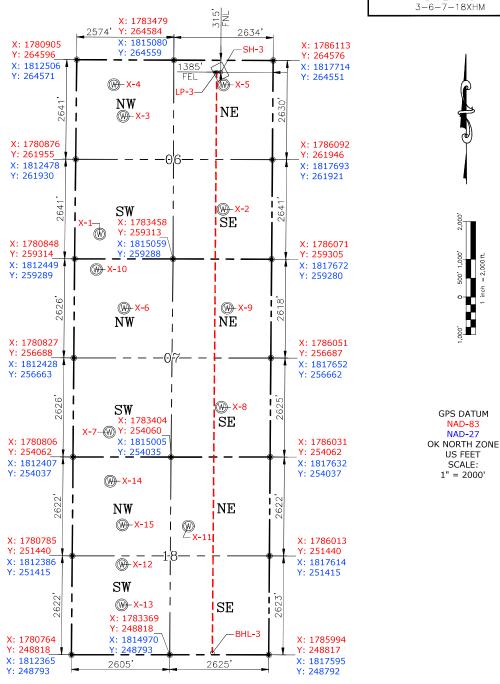

Please note that this location was staked on the ground under the supervision of a Licensed Professional Land Surveyor, but the accuracy of this survey is not guaranteed. Please contact PLS promptly if any inconsistency is determined. GPS data is observed from RTK-GPS. NOTE: X and Y data shown hereon for Section Corners may NOT have been surveyed on-the-ground, and further, does NOT represent a true Boundary Survey. Quarter Section distances may be assumed from a Government Survey Plat or assumed at a proportionate distance from opposing section corners, or occupation thereof, and may not have been measured on-the-ground, and further, does not represent a true Boundary Survey.

#### CERTIFICATE:

I, FRED A. SELENSKY, an Oklahoma Licensed Land Surveyor and an authorized agent of Petro Land Services South, LLC, do hereby certify to the information shown herein.

Fred A. Selensky Selensky 1860

CURRENT REV.: 0
Date Drawn: 01-13-22

0klahoma PLS No.1860 DATE

## EXHIBIT: \_\_

8.5x11 SHEET:

6-14N-13W SHL: 18-14N-13W BHL-3:


#### PETRO LAND SERVICES SOUTH, LLC

14612 BOGERT PARKWAY, OKLA. CITY, OKLA. 73134 \* OFFICE (405) 212-3108 Certificate of Authorization No. 7318



CONTINENTAL RESOURCES, INC (OPERATOR)

**BLAINE** \_ County Oklahoma 315' FNL-1385' FEL Section \_  $\frac{6}{100}$  Township  $\frac{14N}{100}$  Range  $\frac{13W}{100}$  I.M.

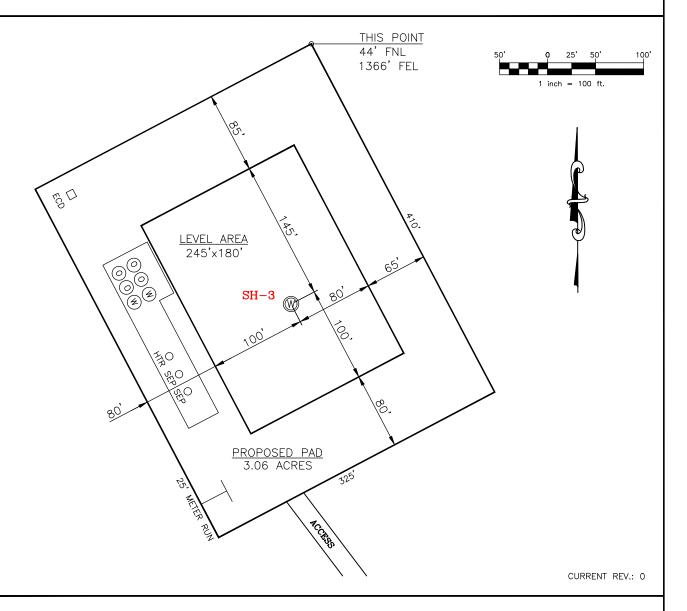

SH-3: B PERKINS 3-6-7-18XHM

DATUM: NAD-83

NORTHING: 264265

1784726 EASTING:

LAT: N35°43'27.69"

LONG: W98°37'08.86"

LAT: 35.724359°

LONG: -98.619126°

STATE PLANE COORDINATES

NORTH (US FEET):

This Information Was Gathered With a GPS Receiver With ±1 Foot Horiz./Vert. Accuracy Operator: CONTINENTAL RESOURCES, INC.

Lease Name: \_\_\_

Pasture Topography & Vegetation:

Good Drill Site? Yes Reference Stakes or Alternate Location Stakes Set: \_

Best Accessibility to Location: From The South Line

Distance & Direction From Hwy. or Town: Leaving Thomas, head northeast on SH-33 for 1.13 miles & turn right on SH-54. Head south for 1.80 miles & turn left on E-0890 Rd. Head east for 4.50 miles &

turn right on N-2445 Rd. & head south for 0.50 miles & turn left on E-0895 Rd. Head east for 0.50 miles

& turn right on N-2450 Rd. Head south for 0.50 miles & turn left on E-0990 Rd. Head east for 0.24

miles to the existing access road.

THE INFORMATION SHOWN HEREIN IS FOR CONSTRUCTION PURPOSES ONLY

LANDING POINT, BOTTOM HOLE AND DRILL PATH INFORMATION PROVIDED BY OPERATOR LISTED, NOT SURVEYED.

Well SH-3: B PERKINS 3-6-7-18XHM

Certificate of Authorization No. 7318




Prepared By: 14612 Bogert Parkway Oklahoma City, OK 73134 EXHIBIT: \_\_\_\_\_C


SHEET: 8.5×11

SHL:  $\frac{6-14N-13W}{18-14N-13W}$ 



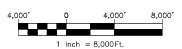

## VICINITY MAP

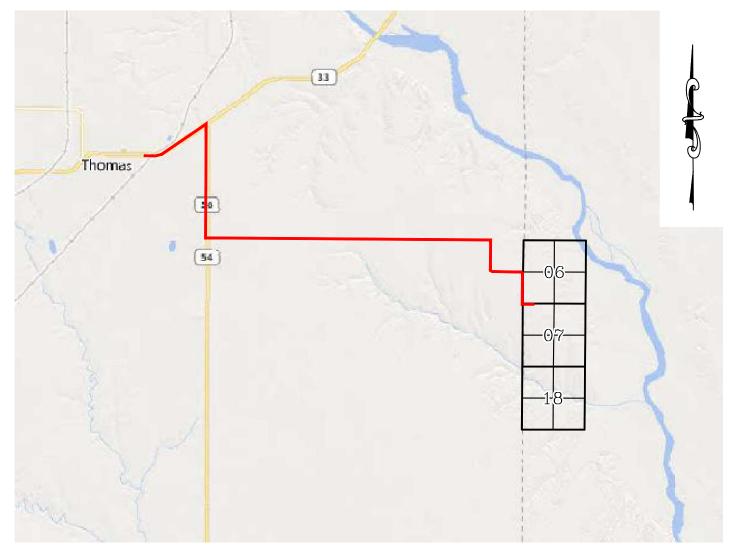

LEAVING THOMAS, HEAD NORTHEAST ON SH-33 FOR 1.13 MILES & TURN RIGHT ON SH-54. HEAD SOUTH FOR 1.80 MILES & TURN LEFT ON E-0890 RD. HEAD EAST FOR 4.50 MILES & TURN RIGHT ON N-2445 RD. & HEAD SOUTH FOR 0.50 MILES & TURN LEFT ON E-0895 RD. HEAD EAST FOR 0.50 MILES & TURN RIGHT ON N-2450 RD. HEAD SOUTH FOR 0.50 MILES & TURN LEFT ON E-0990 RD. HEAD EAST FOR 0.24 MILES TO THE EXISTING ACCESS ROAD.

### CONTINENTAL RESOURCES, INC.

P.O. BOX 26900 OKLAHOMA CITY, OK 73126 \* (T) 1-800-256-8955 (F) 405-234-9253



Prepared By: Petro Land Services South 14612 Bogert Parkway Oklahoma City, OK 73134

Section6	Township	14NRange	13W I.M.	Well SH-3:B	PERKINS	3-6-7-18XHM
County	BLAINE	State	OK			

Operator \_\_\_\_\_CONTINENTAL RESOURCES, INC.

EXHIBIT: \_\_\_

SHEET: <u>8.5x11</u>

SHL:

6 - 14N - 13W

BHL-3: <u>18-14N-13W</u>



Well SH-3: B PERKINS 3-6-7-18XHM

#### FACING NORTH

(NO IMAGES AVAILABLE)

### FACING SOUTH

(NO IMAGES AVAILABLE)

CURRENT REV.: 0

Prepared By:



TERRAIN

DRAWN BY:	HDG	SCALE:	N.T.S.
CHECKED BY:	MJL	JOB No.:	
APPROVED BY:		DWG. NO.:	TERRAIN-1
DATE ISSUED:	01-13-22	SHEET:	1 OF 2

EXHIBIT: \_\_\_\_E

SHEET: <u>8.5x11</u>

SHL:

6 - 14N - 13W

BHL-3: <u>18-14N-13W</u>



Well SH-3: B PERKINS 3-6-7-18XHM

#### FACING EAST

(NO IMAGES AVAILABLE)

### FACING WEST

(NO IMAGES AVAILABLE)

CURRENT REV.: 0

Prepared By:



TERRAIN


DRAWN BY:	HDG	SCALE:	N.T.S.
CHECKED BY:	MJL	JOB No.:	
APPROVED BY:		DWG. NO.:	TERRAIN-2
DATE ISSUED:	01-13-22	SHEET:	2 OF 2

EXHIBIT: \_\_\_\_F

SHEET:  $\frac{8.5 \times 11}{6 - 14 N - 13 W}$ BHL-3:  $\frac{18 - 14 N - 13 W}{18 - 14 N - 13 W}$ 




PROPOSED ACCESS ROAD = 6272' | 380.12 RODS (TOTAL)

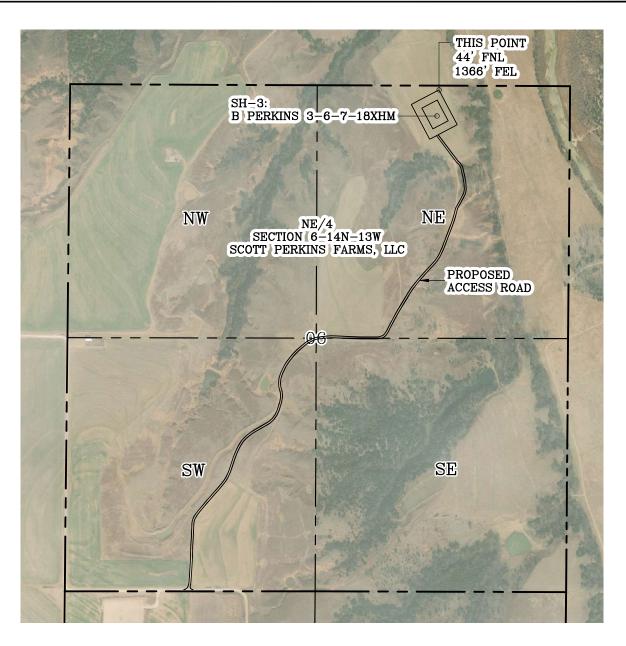

Section  $\frac{6}{}$  Township  $\frac{14N}{}$  Range  $\frac{13W}{}$  I.M.

County BLAINE State OK

Operator CONTINENTAL RESOURCES, INC.

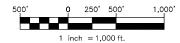

CURRENT REV.: 0


Prepared



# AERIAL PLAT

DRAWN BY:	HDG	SCALE:	1" = 1000'
CHECKED BY:	MJL	JOB No.:	
APPROVED BY:		DWG. NO.:	AERIAL-1
DATE ISSUED:	01-13-22	SHEET:	1 OF 4

GPS DATUM - NAD83, OK NORTH ZONE US FEET SCALE: 1" = 1000'

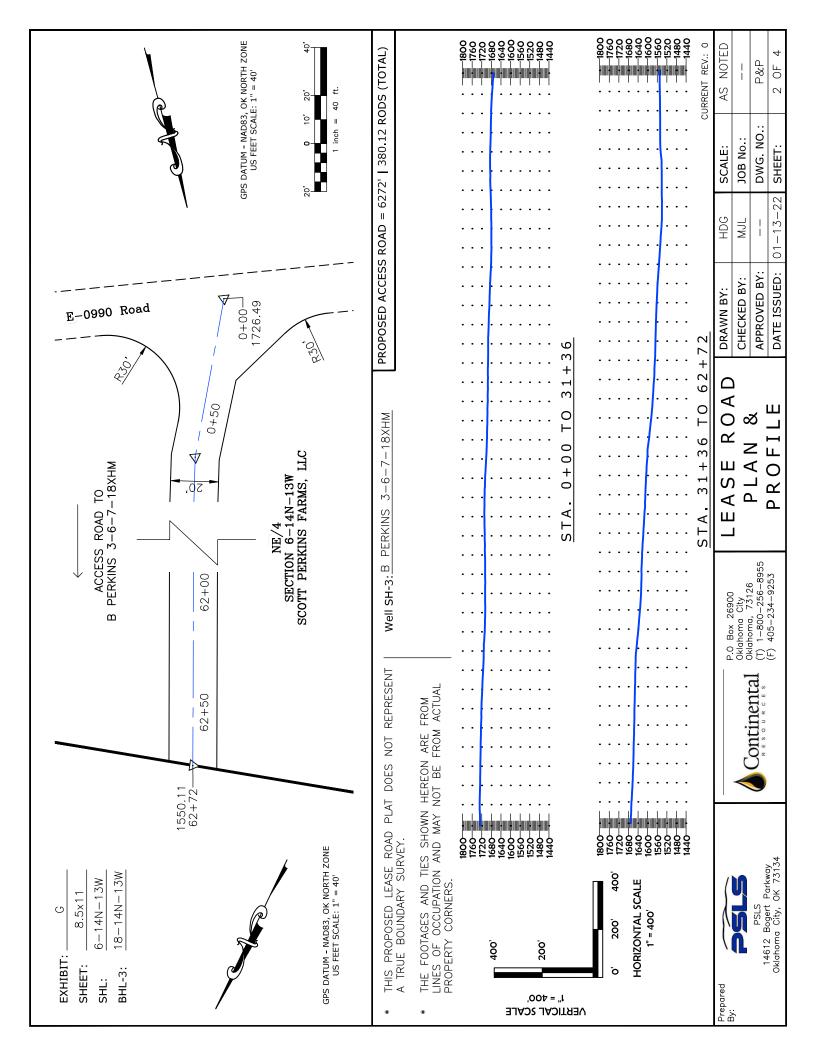

Well SH-3: B PERKINS 3-6-7-18XHM

EXHIBIT: H

SHEET: 8.5x11

SHL:  $\frac{6-14N-13W}{18-14N-13W}$ 





CURRENT REV.: 0

Prepared By:



EXISTING GRADING PLAN


DRAWN BY:	HDG	SCALE:	1" = 100'
CHECKED BY:	MJL	JOB No.:	
APPROVED BY:		DWG. NO.:	EX-GR.
DATE ISSUED:	01-13-22	SHEET:	3 OF 4

EXHIBIT: \_\_\_\_\_\_ | 8.5×11

SHL:  $\frac{6-14N-13W}{18-14N-13W}$ 



#### TOTAL PROPOSED DISTURBED AREA: 4.20 ACRES

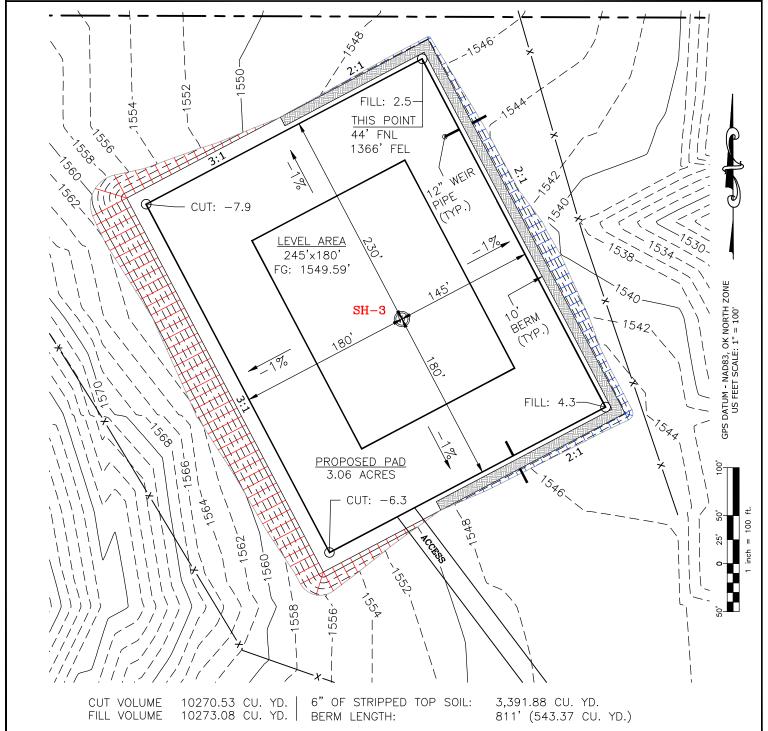

(CUT/FILL VOLUMES DO NOT INCLUDE 6" OF STRIPPED TOP SOIL)

CURRENT REV.: 0

Prepared



PROPOSED GRADING PLAN

DRAWN BY:	HDG	SCALE:	1" = 100'
CHECKED BY:	MJL	JOB No.:	
APPROVED BY:		DWG. NO.:	PRO-GR.
DATE ISSUED:	01-13-22	SHEET:	4 OF 4

# EXHIBIT "A"


TABLE OF QUANTITIES

DISTURBED AREA = 4.20 ACRES ACCESS ROAD =  $\pm 6272$ '

LOCATED ON THE LANDS OF: SCOTT PERKINS FARMS, LLC

NE/4 SEC 6-14N-13W BLAINE COUNTY, OKLAHOMA



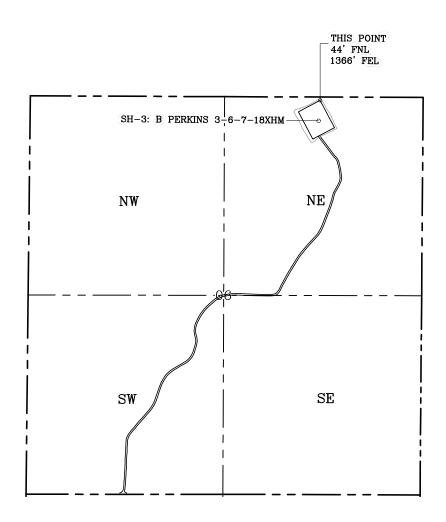

#### **GENERAL NOTES:**

- 1. THIS IS NOT A BOUNDARY SURVEY.
- 2. THIS SURVEY DOES NOT GUARANTEE TITLE OR OWNERSHIP.

