API NUMBER: 051 24895

OKLAHOMA CORPORATION COMMISSION OIL & GAS CONSERVATION DIVISION P.O. BOX 52000 OKLAHOMA CITY, OK 73152-2000 (Rule 165:10-3-1)

Approval Date: 12/15/2021

Expiration Date: 06/15/2023

Multi Unit Oil & Gas

PERMIT TO DRILL

WELL LOCATION: Section: 17 Township: 6N Range: 6W C	county: GRADY
SPOT LOCATION: SE SW SW SW FEET FROM QUARTER: FROM S	OUTH FROM WEST
SECTION LINES: 2	30 490
Lease Name: GEORGE Well No: 3	-17-8XHM Well will be 230 feet from nearest unit or lease boundary.
Operator Name: CONTINENTAL RESOURCES INC Telephone: 4	052349797; 4052349000; OTC/OCC Number: 3186 0
CONTINENTAL RESOURCES INC	MACK PROPERTIES LIMITED PARTNERSHIP
PO BOX 268870	C/O ALICE MUSSER
OKLAHOMA CITY, OK 73126-8870	2248 LANE WAY DRIVE
	OKLAHOMA CITY OK 73159
Franchise (a) (Berni'l Vell'd (and interdent American Oak)	
Formation(s) (Permit Valid for Listed Formations Only):	
Name Code Depth	
1 MISSISSIPPIAN 359MSSP 14869	
Spacing Orders: 611024 Location Exception	on Orders: No Exceptions Increased Density Orders: No Density
Pending CD Numbers: 202102561 Working interest	est owners' notified: *** Special Orders: No Special
202102562	
202102564	
202102568	
202102569	
	Doubt to been of Treatable Water Pengins FM, 500
Total Depth: 25053 Ground Elevation: 1059 Surface Ca	Depth to base of Treatable Water-Bearing FM: 520
	Deep surface casing has been approved
Under Federal Jurisdiction: No	Approved Method for disposal of Drilling Fluids:
Fresh Water Supply Well Drilled: No	D. One time land application (REQUIRES PERMIT) PERMIT NO: 21-37985
Surface Water used to Drill: Yes	
	H. (Other) SEE MEMO
PIT 1 INFORMATION	
PIT 1 INFORMATION Type of Pit System: CLOSED Closed System Means Steel Pits	Category of Pit: C
Type of Pit System: CLOSED Closed System Means Steel Pits	Category of Pit: C Liner not required for Category: C
Type of Pit System: CLOSED Closed System Means Steel Pits Type of Mud System: WATER BASED	Category of Pit: C Liner not required for Category: C Pit Location is: ALLUVIAL
Type of Pit System: CLOSED Closed System Means Steel Pits Type of Mud System: WATER BASED Chlorides Max: 5000 Average: 3000	Category of Pit: C Liner not required for Category: C Pit Location is: ALLUVIAL
Type of Pit System: CLOSED Closed System Means Steel Pits Type of Mud System: WATER BASED Chlorides Max: 5000 Average: 3000 Is depth to top of ground water greater than 10ft below base of pit? Y	Category of Pit: C Liner not required for Category: C Pit Location is: ALLUVIAL
Type of Pit System: CLOSED Closed System Means Steel Pits Type of Mud System: WATER BASED Chlorides Max: 5000 Average: 3000 Is depth to top of ground water greater than 10ft below base of pit? Y Within 1 mile of municipal water well? N	Category of Pit: C Liner not required for Category: C Pit Location is: ALLUVIAL
Type of Pit System: CLOSED Closed System Means Steel Pits Type of Mud System: WATER BASED Chlorides Max: 5000 Average: 3000 Is depth to top of ground water greater than 10ft below base of pit? Y Within 1 mile of municipal water well? N Wellhead Protection Area? N Pit <u>is</u> located in a Hydrologically Sensitive Area.	Category of Pit: C Liner not required for Category: C Pit Location is: ALLUVIAL
Type of Pit System: CLOSED Closed System Means Steel Pits Type of Mud System: WATER BASED Chlorides Max: 5000 Average: 3000 Is depth to top of ground water greater than 10ft below base of pit? Y Within 1 mile of municipal water well? N Wellhead Protection Area? N	Category of Pit: C Liner not required for Category: C Pit Location is: ALLUVIAL Pit Location Formation: ALLUVIUM
Type of Pit System: CLOSED Closed System Means Steel Pits Type of Mud System: WATER BASED Chlorides Max: 5000 Average: 3000 Is depth to top of ground water greater than 10ft below base of pit? Y Within 1 mile of municipal water well? N Wellhead Protection Area? N Pit <u>is</u> located in a Hydrologically Sensitive Area. PIT 2 INFORMATION	Category of Pit: C Liner not required for Category: C Pit Location is: ALLUVIAL Pit Location Formation: ALLUVIUM Category of Pit: C
Type of Pit System: CLOSED Closed System Means Steel Pits Type of Mud System: WATER BASED Chlorides Max: 5000 Average: 3000 Is depth to top of ground water greater than 10ft below base of pit? Y Within 1 mile of municipal water well? N Wellhead Protection Area? N Pit is located in a Hydrologically Sensitive Area. PIT 2 INFORMATION Type of Pit System: CLOSED Closed System Means Steel Pits	Category of Pit: C Liner not required for Category: C Pit Location is: ALLUVIAL Pit Location Formation: ALLUVIUM Category of Pit: C Liner not required for Category: C
Type of Pit System: CLOSED Closed System Means Steel Pits Type of Mud System: WATER BASED Chlorides Max: 5000 Average: 3000 Is depth to top of ground water greater than 10ft below base of pit? Y Within 1 mile of municipal water well? N Wellhead Protection Area? N Pit <u>is</u> located in a Hydrologically Sensitive Area. PIT 2 INFORMATION Type of Pit System: CLOSED Closed System Means Steel Pits Type of Mud System: OIL BASED	Category of Pit: C Liner not required for Category: C Pit Location is: ALLUVIAL Pit Location Formation: ALLUVIUM Category of Pit: C Liner not required for Category: C Pit Location is: ALLUVIAL
Type of Pit System: CLOSED Closed System Means Steel Pits Type of Mud System: WATER BASED Chlorides Max: 5000 Average: 3000 Is depth to top of ground water greater than 10ft below base of pit? Y Within 1 mile of municipal water well? N Wellhead Protection Area? N Pit <u>is</u> located in a Hydrologically Sensitive Area. PIT 2 INFORMATION Type of Pit System: CLOSED Closed System Means Steel Pits Type of Mud System: OIL BASED Chlorides Max: 300000 Average: 200000	Category of Pit: C Liner not required for Category: C Pit Location is: ALLUVIAL Pit Location Formation: ALLUVIUM Category of Pit: C Liner not required for Category: C Pit Location is: ALLUVIAL
Type of Pit System: CLOSED Closed System Means Steel Pits Type of Mud System: WATER BASED Chlorides Max: 5000 Average: 3000 Is depth to top of ground water greater than 10ft below base of pit? Y Within 1 mile of municipal water well? N Wellhead Protection Area? N Pit is located in a Hydrologically Sensitive Area. PIT 2 INFORMATION Type of Pit System: CLOSED Closed System Means Steel Pits Type of Mud System: OIL BASED Chlorides Max: 300000 Average: 200000 Is depth to top of ground water greater than 10ft below base of pit? Y	Category of Pit: C Liner not required for Category: C Pit Location is: ALLUVIAL Pit Location Formation: ALLUVIUM Category of Pit: C Liner not required for Category: C Pit Location is: ALLUVIAL

MULTI UNIT HOLE 1

Section: 8 Township: 6N Range: 6W Meridian: IM Total Length: 9936

County: GRADY Measured Total Depth: 25053

Spot Location of End Point: NE NE NW NW True Vertical Depth: 16000

Feet From: NORTH 1/4 Section Line: 50 End Point Location from
Feet From: WEST 1/4 Section Line: 1230 Lease,Unit, or Property Line: 50

NOTES:	
Category	Description
DEEP SURFACE CASING	[12/1/2021 - GC2] - APPROVED; NOTIFY OCC FIELD INSPECTOR IMMEDIATELY OF ANY LOSS OF CIRCULATION OR FAILURE TO CIRCULATE CEMENT TO SURFACE ON ANY CONDUCTOR OR SURFACE CASING
HYDRAULIC FRACTURING	[12/1/2021 - GC2] - OCC 165:10-3-10 REQUIRES:
	1) NOTICE SHALL BE GIVEN AT LEAST 5 BUSINESS DAYS PRIOR TO COMMENCEMENT OF HYDRAULIC FRACTURING OPERATIONS ON A HORIZONTAL WELL TO OPERATORS PRODUCING WELLS WITHIN 1 MILE OF THE COMPLETION INTERVAL OF THE SUBJECT WELL. THE NOTICE TO SUCH OPERATORS SHALL CONTAIN THE INFORMATION IN FORM 6000NOO. IF THE HYDRAULIC FRACTURING OPERATIONS SCHEDULE CHANGES AFTER NOTICE HAS BEEN PROVIDED, RESULTING IN A DELAY OF OPERATIONS OF MORE THAN 5 DAYS FROM THE INITIAL NOTICE, NEW NOTICE IS REQUIRED TO BE GIVEN;
	2) NOTICE WILL BE GIVEN TO THE OCC CENTRAL OFFICE AND LOCAL DISTRICT OFFICES AT LEAST 48 HOURS PRIOR TO COMMENCEMENT OF HYDRAULIC FRACTURING OPERATIONS. FORM 6000NHF SHALL BE USED AND IS FOUND AT THIS LINK: OCCEWEB.COM/OG/OGFORMS.HTML; AND,
	3) THE CHEMICAL DISCLOSURE OF HYDRAULIC FRACTURING INGREDIENTS FOR ALL WELLS IS TO BE REPORTED TO FRACFOCUS WITHIN 60 DAYS AFTER THE CONCLUSION OF HYDRAULIC FRACTURING OPERATIONS, FOUND AT FRACFOCUS.ORG
MEMO	[12/1/2021 - GC2] - CLOSED SYSTEM=STEEL PITS (REQUIRED - BITTER CREEK AND WASHITA RIVER), OBM RETURNED TO VENDOR, CUTTINGS PERMITTED PER DISTRICT
PENDING CD – 202102561	[12/14/2021 - GB6] - (I.O.)(640) 8-6N-6W EXT 624300 MSSP, OTHERS REC. 12/14/2021 (MILLER)
PENDING CD – 202102562	[12/14/2021 - GB6] - (I.O.) 17-6N-6W X611024 MSSP, OTHER OTHER 3 WELLS MSSP 1 WELL NO OPER. NAMED REC. 12/14/2021 (MILLER)
PENDING CD – 202102564	[12/14/2021 - GB6] - (I.O.) 8-6N-6W X202102561 MSSP, OTHER OTHER 2 WELLS MSSP 1 WELL NO OPER. NAMED REC. 12/14/2021 (MILLER)
PENDING CD – 202102568	[12/14/2021 - GB6] - (I.O.) 17 & 8 -6N-6W EST MULTIUNIT HORIZONTAL WELL X611204 MSSP, OTHER 17-6N-6W X202102561 MSSP, OTHER 8-6N-6W (OTHER ADJACENT COMMON SOURCE OF SUPPLY TO MSSP) 50% 17-6N-6W 50% 8-6N-6W CONTINENTAL RESOURCES, INC. REC. 12/14/2021 (MILLER)
PENDING CD – 202102569	[12/14/2021 - GB6] - (I.O.) 17 & 8 -6N-6W X611204 MSSP, OTHER 17-6N-6W X202102561 MSSP, OTHER 8-6N-6W COMPL. INT. (17-6N-6W) NCT 150' FSL, NCT 0' FNL, NCT 660' FWL COMPL. INT. (8-6N-6W) NCT 0' FSL, NCT 150' FNL, NCT 660' FWL CONTINENTAL RESOURCES, INC. REC. 12/14/2021 (MILLER)
SPACING - 611024	[12/14/2021 - GB6] - (640) 17-6N-6W EXT 609305 MSSP, OTHERS

EXHIBIT: <u>A (1 of 3)</u> SHEET: 8.5×14 17-6N-6W SHL: BHL-2: 8-6N-6W BHL-3: 8-6N-6W



WELL PAD ID: AE945B00-6A0A-80D4-5DF8-C60C4E05D6A8

SH-2-ID: P5SIC73A7X SH-3-ID: W5CJ10G4QR

COVER SHEET

$\frac{\text{CONTINENTAL}}{\text{P.O. BOX 26900 OKLAHOMA CITY, OK 73126 * (T) 1-800-256-8955 (F) 405-234-9253}}$ INC.

SH-2: GEORGE 2-17-8XHW Section _____17__ Township ____6N__ Range ___6W__ I.M. SH-3: ____GEORGE 3-17-8XHM __State ____OK___ GRADY

CONTINENTAL RESOURCES, INC. Operator _

						1		
	NAD-83							
POINT	WELL NAME	NORTHING	EASTING	LATITUDE LONGITUDE	LATITUDE LONGITUDE		EXISTING ELEVATION	DESIGN ELEVATION
SH-2	GEORGE 2-17-8XHW	601670	2009568	34° 59′ 11.51″ -97° 51′ 46.42″	34.986530 -97.862895	230' FSL / 460' FWL (SE/4 SW/4 SW/4 SW/4 SEC 17)	1058.03'	1059.22
LP-2	LANDING POINT	601670	2009438	34° 59′ 11.51″ -97° 51′ 47.98″	34.986530 -97.863329	230' FSL / 330' FWL (SW/4 SEC 17)		
BHL-2	BOTTOM HOLE LOCATION	611966	2009406	35° 00' 53.35" -97° 51' 48.20"	35.014820 -97.863389	50' FNL / 330' FWL (NW/4 SEC 8)		
SH-3	GEORGE 3-17-8XHM	601670	2009598	34° 59′ 11.51″ -97° 51′ 46.06″	34.986530 -97.862795	230' FSL / 490' FWL (SE/4 SW/4 SW/4 SW/4 SEC 17)	1058.00'	1059.22
LP-3	LANDING POINT	601670	2010338	34° 59' 11.50" -97° 51' 37.17"	34.986528 -97.860324	230' FSL / 1230' FWL (SW/4 SEC 17)		
BHL-3	BOTTOM HOLE LOCATION	611968	2010306	35° 00′ 53.36″ -97° 51′ 37.38″	35.014821 -97.860383	50' FNL / 1230' FWL (NW/4 SEC 8)		
X-1	MECOY #1	602760	2010158	34° 59' 22.28" -97° 51' 39.31"	34.989523 -97.860920	17-6N-6W: TD: 13460' 1320' FSL / 1050' FWL		
X-2	IRENE CALVERT #1	605405	2010422	34° 59′ 48.44″ -97° 51′ 36.10″	34.996789 -97.860028	17-6N-6W: TD: 13600' 1325' FNL / 1320' FWL		
X-3	GEORGE #1-17H	601612	2013782	34° 59' 10.87" -97° 50' 55.78"	34.986354 -97.848828	17-6N-6W: TD: 19531' 170' FSL / 600' FEL		
X-4	MCNEIL #1	609370	2010406	35° 00' 27.66" -97° 51' 36.23"	35.007682 -97.860063	8-6N-6W: TD: 13184' 2640' FSL / 1320' FWL		

	NAD-27							
POINT	WELL NAME	NORTHING	EASTING	LATITUDE LONGITUDE	LATITUDE LONGITUDE		EXISTING ELEVATION	DESIGN ELEVATION
SH-2	GEORGE 2-17-8XHW	601628	2041165	34° 59' 11.27" -97° 51' 45.27"	34.986463 -97.862576	230' FSL / 460' FWL (SE/4 SW/4 SW/4 SW/4 SEC 17)	1058.03'	1059.22'
LP-2	LANDING POINT	601628	2041035	34° 59' 11.27" -97° 51' 46.84"	34.986463 -97.863010	230' FSL / 330' FWL (SW/4 SEC 17)		
BHL-2	BOTTOM HOLE LOCATION	611925	2041003	35° 00' 53.11" -97° 51' 47.05"	35.014753 -97.863070	50' FNL / 330' FWL (NW/4 SEC 8)		
SH-3	GEORGE 3-17-8XHM	601628	2041195	34° 59′ 11.26″ -97° 51′ 44.91″	34.986462 -97.862476	230' FSL / 490' FWL (SE/4 SW/4 SW/4 SW/4 SEC 17)	1058.00'	1059.22'
LP-3	LANDING POINT	601629	2041935	34° 59' 11.26" -97° 51' 36.02"	34.986461 -97.860005	230' FSL / 1230' FWL (SW/4 SEC 17)		
BHL-3	BOTTOM HOLE LOCATION	611926	2041903	35° 00′ 53.12" -97° 51′ 36.23"	35.014755 -97.860064	50' FNL / 1230' FWL (NW/4 SEC 8)		
X-1	MECOY #1	602719	2041755	34° 59' 22.04" -97° 51' 38.16"	34.989456 -97.860601	17-6N-6W: TD: 13460' 1320' FSL / 1050' FWL		
X-2	IRENE CALVERT #1	605364	2042018	34° 59′ 48.20″ -97° 51′ 34.95″	34.996722 -97.859709	17-6N-6W: TD: 13600' 1325' FNL / 1320' FWL		
X-3	GEORGE #1-17H	601570	2045378	34° 59' 10.63" -97° 50' 54.63"	34.986287 -97.848509	17-6N-6W: TD: 19531' 170' FSL / 600' FEL		
X-4	MCNEIL #1	609328	2042002	35° 00' 27.42" -97° 51' 35.08"	35.007616 -97.859744	8-6N-6W: TD: 13184' 2640' FSL / 1320' FWL		

REVISIONS No. DATE STAKED BY DESCRIPTION COMMENTS **-**-21 00 11-10-21 HDG ISSUED FOR APPROVAL **-**-21 HDG 11-17-21 REV'D GEORGE 3 NAME REV'D ALL SHEETS



EXHIBIT: A (2 of 3)

8.5x14 SHFFT: 17-6N-6W SHL: 8-6N-6W BHL-2:


PETRO LAND SERVICES SOUTH,

14612 HERTZ QUAIL SPRINGS PKWY, OKLA. CITY, OKLA. 73134 * OFFICE (405) 212-3108 Certificate of Authorization No. 7318






CONTINENTAL RESOURCES, INC (OPERATOR)

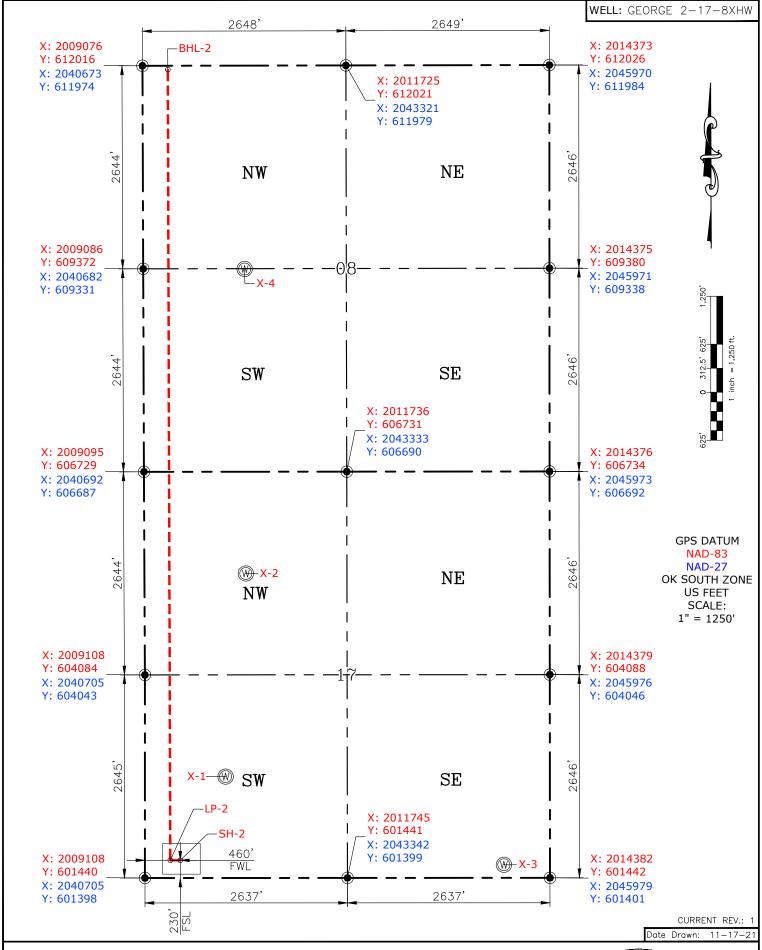

Please note that this location was staked on the ground under the supervision of a Licensed Professional Land Surveyor, but the accuracy of this survey is not guaranteed. Please contact PLS promptly if any inconsistency is determined. GPS data is observed from RTK-GPS. NOTE: X and Y data shown hereon for Section Corners may NOT have been surveyed on-the-ground, and further, does NOT represent a true Boundary Survey. Quarter Section distances may be assumed from a Government Survey Plat or assumed at a proportionate distance from opposing section corners, or occupation thereof, and may not have been measured on-the-ground, and further, does not represent a true Boundary Survey.

CERTIFICATE:

I, FRED A. SELENSKY, an Oklahoma Licensed Land Surveyor and an authorized agent of Petro Land Services South, LLC, do hereby certify to the information shown herein.

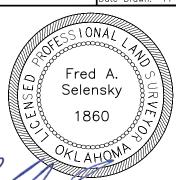

//-17-21 Oklahoma PLS No.1860 DATE


EXHIBIT: A (3 of 3)

8.5x14


SHFFT: 17-6N-6W SHL: 8-6N-6W BHL-3:

PETRO LAND SERVICES SOUTH, LL 14612 HERTZ QUAIL SPRINGS PKWY, OKLA. CITY, OKLA. 73134 * OFFICE (405) 212-3108 Certificate of Authorization No. 7318

GRADY County Oklahoma 230' FSL-490' FWL Section ______ Township _ 6N Range 6W I.M.

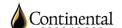


CONTINENTAL RESOURCES, INC (OPERATOR)

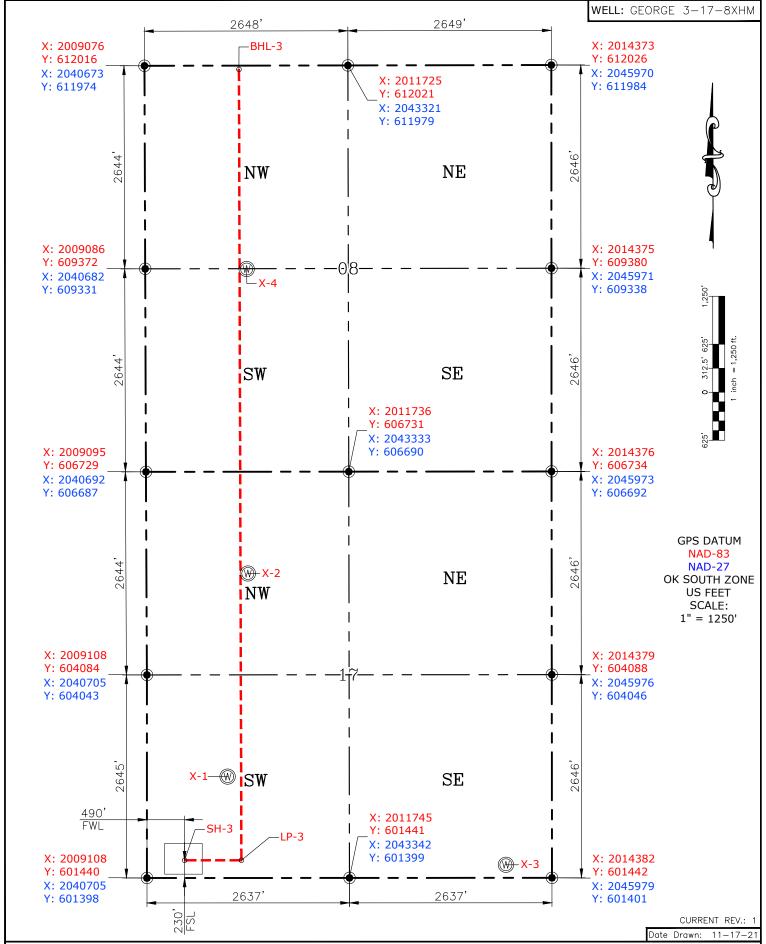

Please note that this location was staked on the ground under the supervision of a Licensed Professional Land Surveyor, but the accuracy of this survey is not guaranteed. Please contact PLS promptly if any inconsistency is determined. GPS data is observed from RTK-GPS. NOTE: X and Y data shown hereon for Section Corners may NOT have been surveyed on-the-ground, and further, does NOT represent a true Boundary Survey. Quarter Section distances may be assumed from a Government Survey Plat or assumed at a proportionate distance from opposing section corners, or occupation thereof, and may not have been measured on-the-ground, and further, does not represent a true Boundary Survey.

CERTIFICATE:

I, FRED A. SELENSKY, an Oklahoma Licensed Land Surveyor and an authorized agent of Petro Land Services South, LLC, do hereby certify to the information shown herein.

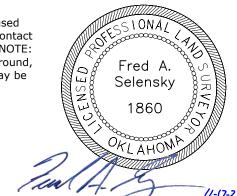

Oklahoma PLS No.1860

DATE

EXHIBIT: _

8.5x11 SHEET:

SHL:

17-6N-6W

8-6N-6W BHL-2: 8-6N-6W BHL-3:


PETRO LAND SERVICES SOUTH, LLC

14612 HERTZ QUAIL SPRINGS PKWY, OKLA. CITY, OKLA. 73134 * OFFICE (405) 212-3108 Certificate of Authorization No. 7318



CONTINENTAL RESOURCES, INC (OPERATOR)

GRADY SH-2: 230' FSL-460' FWL _ County Oklahoma SH-3: 230' FSL-490' FWL Section 17 Township $\frac{6N}{}$ Range $\frac{6W}{}$ I.M.

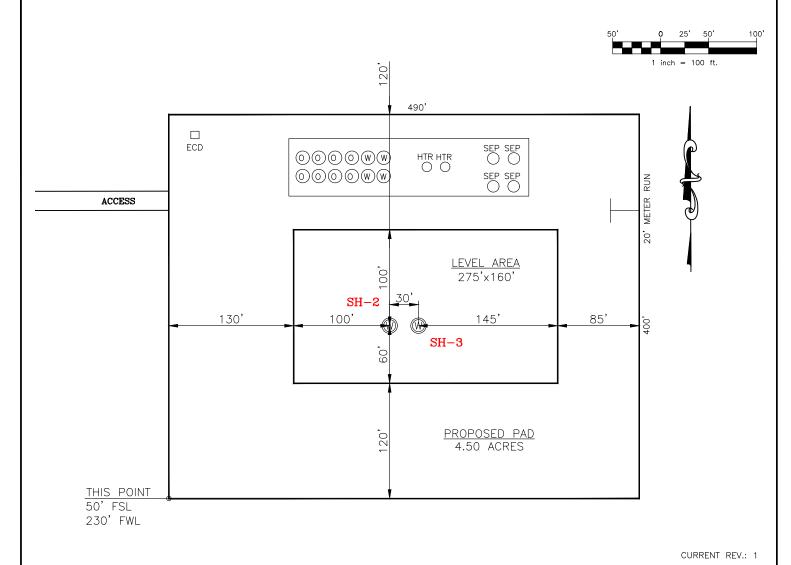

SH-2: GEORGE 2-17-8XHW SH-3: GEORGE 3-17-8XHM DATUM: DATUM: NAD-83 NAD-83 NORTHING: 601670 NORTHING: 601670 2009568 2009598 EASTING: EASTING: LAT: <u>N34°59'1</u>1.51" LAT: N34°59'11.51" LONG: W97°51'46.42" LONG: W97°51'46.06" LAT: LAT: 34.986530° 34.986530° LONG: -97.862895° LONG: -97.862795° STATE PLANE COORDINATES SOUTH (US FEET):

Operator: CONTINENTAL RESOURCES, INC.

Lease Name: ___

Topography & Vegetation: Pasture Good Drill Site?

Reference Stakes or Alternate Location Stakes Set: _

Best Accessibility to Location: From The West Line

Distance & Direction From Hwy. or Town: Leaving Chickasha, head south on SH-277 for 4.09 miles & turn left on SH-19. Head east for 3.51 miles & turn left on

Willow Rd. Head east for 0.81 miles to the proposed access road.

THE INFORMATION SHOWN HEREIN IS FOR CONSTRUCTION **PURPOSES ONLY**

GEORGE 2-17-8XHW Well SH-2:

GEORGE 3-17-8XHM Well SH-3:

This Information Was Gathered With a GPS Receiver With ±1 Foot Horiz./Vert. Accuracy Certificate of Authorization No. 7318

LANDING POINT, BOTTOM HOLE AND DRILL PATH INFORMATION PROVIDED BY OPERATOR LISTED, NOT SURVEYED.




14612 Hertz Quail Springs Pkwy. Oklahoma City, OK 73134

EXHIBIT: ______C
SHEET: _____8.5x11


SHL: $\frac{17-6N-6W}{8-6N-6W}$

BHL-3: 8-6N-6W



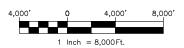

VICINITY MAP

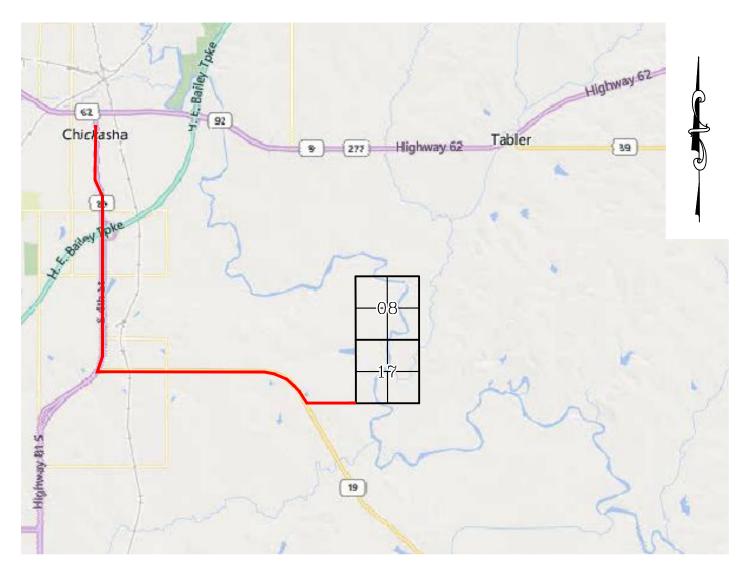

LEAVING CHICKASHA, HEAD SOUTH ON SH-277 FOR 4.09 MILES & TURN LEFT ON SH-19. HEAD EAST FOR 3.51 MILES & TURN LEFT ON WILLOW RD. HEAD EAST FOR 0.81 MILES TO THE PROPOSED ACCESS ROAD.

CONTINENTAL RESOURCES, INC.

P.O. BOX 26900 OKLAHOMA CITY, OK 73126 * (T) 1-800-256-8955 (F) 405-234-9253

$\overline{}$	
5L	5

Prepared By: Petro Land Services South 14612 Hertz Quail Springs Pkwy. Oklahoma City, OK 73134

Section	17 Township6N	Range _	6WI.M.	Well SH-2:	GEORGE 2-17-8XHW
County	GRADY	State _	OK	Well SH-3:	GEORGE 3-17-8XHM
Operator	CONTINENTAL R	ESOURCES,	INC.		

Certificate of Authorization No. 7318

EXHIBIT: D 8.5x11

SHEET: $\frac{8.5 \times 11}{17 - 6 N - 6 W}$

BHL-2: 8-6N-6W

BHL-3: 8-6N-6W



Well SH-2: GEORGE 2-17-8XHW

Well SH-3: GEORGE 3-17-8XHM

FACING NORTH

(NO IMAGES AVAILABLE)

FACING SOUTH

(NO IMAGES AVAILABLE)

CURRENT REV.: 1

Prepared By:



TERRAIN

DRAWN BY:	HDG	SCALE:	N.T.S.
CHECKED BY:	MJL	JOB No.:	
APPROVED BY:		DWG. NO.:	TERRAIN-1
DATE ISSUED:	11-17-21	SHFFT:	1 OF 2

EXHIBIT: ____E

SHEET: 8.5x11

SHL: $\frac{17-6N-6W}{8-6N-6W}$

BHL-3: 8-6N-6W



Well SH-2: GEORGE 2-17-8XHW

Well SH-3: GEORGE 3-17-8XHM

FACING EAST

(NO IMAGES AVAILABLE)

FACING WEST

(NO IMAGES AVAILABLE)

CURRENT REV.: 1

Prepared By:



TERRAIN

DRAWN BY:	HDG	SCALE:	N.T.S.
CHECKED BY:	MJL	JOB No.:	
APPROVED BY:		DWG. NO.:	TERRAIN-2
DATE ISSUED:	11-17-21	SHEET:	2 OF 2

SHEET: ____8.5x11

17-6N-6W SHL: 8-6N-6W BHL-2: 8-6N-6W


BHL-3:



Well SH-2: GEORGE 2-17-8XHW


Well SH-3: GEORGE 3-17-8XHM

PROPOSED ACCESS ROAD = 234' | 14.18 RODS (TOTAL)

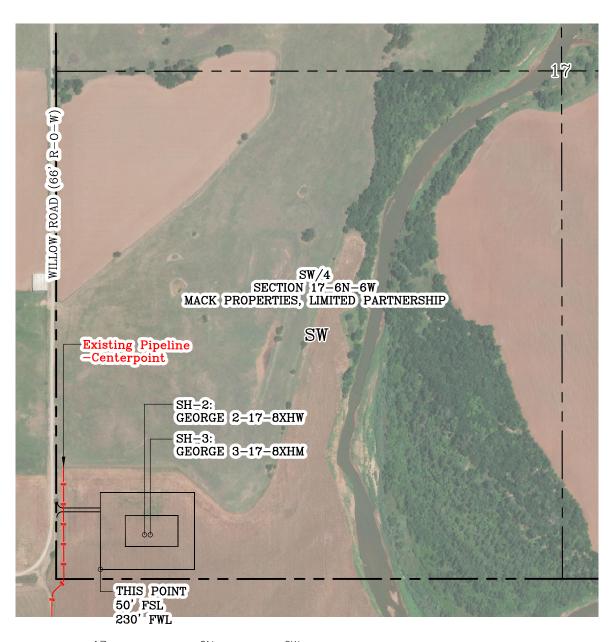

Section _______ Township ______ 6N ___ Range _____ 6W ___ I.M. GRADY _State ___OK___ County __

CONTINENTAL RESOURCES, INC.

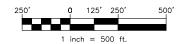


CURRENT REV.: 1

Prepared





AERIAL PLAT 14612 Hertz Quail Springs Pkwy. Oklahoma City, OK 73134

DRAWN BY:	HDG	SCALE:	1" = 500'
CHECKED BY:	MJL	JOB No.:	
APPROVED BY:		DWG. NO.:	AERIAL-1
DATE ISSUED:	11-17-21	SHEET:	1 OF 4

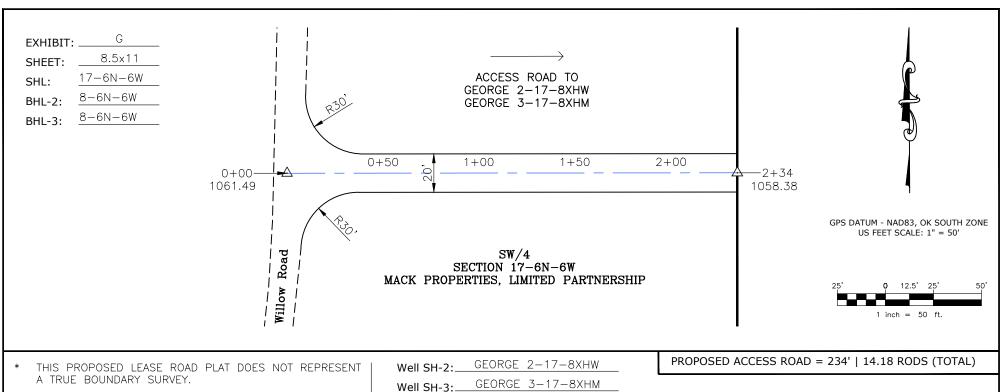

THE FOOTAGES AND TIES SHOWN HEREON ARE FROM LINES OF OCCUPATION AND MAY NOT BE FROM ACTUAL PROPERTY CORNERS.

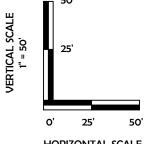

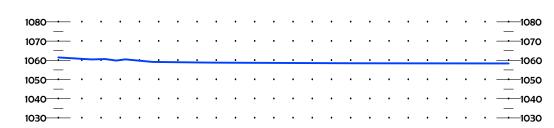

HORIZONTAL SCALE 1" = 50'

CURRENT REV.: 1

Prepared By:





P.O Box 26900 Oklahoma City Oklahoma, 73126 (T) 1-800-256-8955 (F) 405-234-9253

LEASE ROAD PLAN & PROFILE

DRAWN BY:	HDG	SCALE:	AS NOTED
CHECKED BY:	MJL	JOB No.:	
APPROVED BY:		DWG. NO.:	P&P
DATE ISSUED:	11-17-21	SHEET:	2 OF 4

EXHIBIT: _

8.5x11 SHEET:

17-6N-6W SHL:


BHL-2: 8 - 6N - 6WBHL-3:

8-6N-6W



GEORGE 2-17-8XHW Well SH-2:_

GEORGE 3-17-8XHM Well SH-3:_

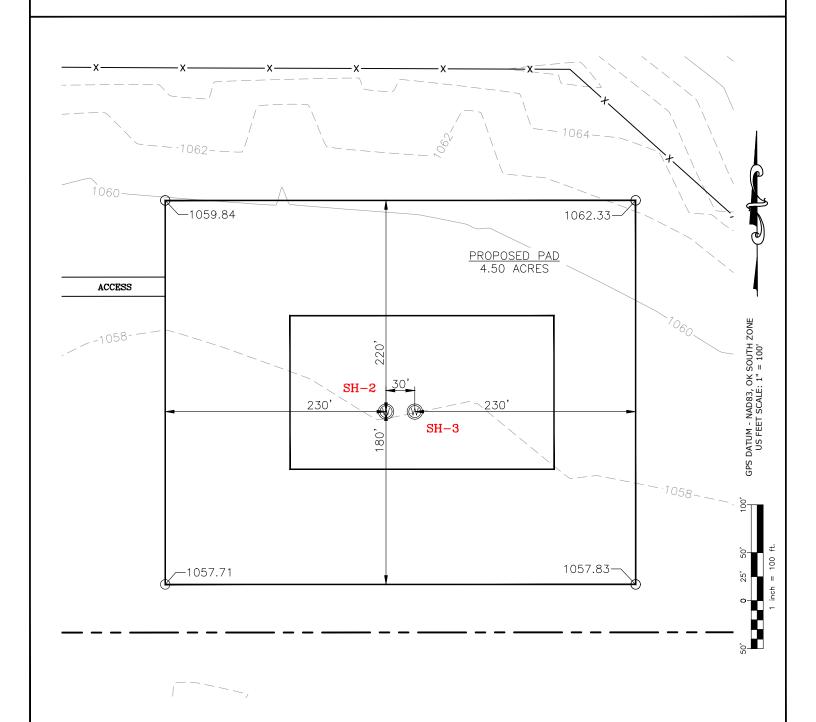

CURRENT REV.: 1

Prepared By:



14612 Hertz Quail Springs Pkwy. Oklahoma City, OK 73134

EXISTING GRADING PLAN

DRAWN BY:	HDG	SCALE:	1" = 100'
CHECKED BY:	MJL	JOB No.:	
APPROVED BY:		DWG. NO.:	EX-GR.
DATE ISSUED:	11-17-21	SHEET:	3 OF 4

EXHIBIT: __

8.5x11 SHEET:

SHL: 8-6N-6W BHL-2:

17-6N-6W


8 - 6N - 6WBHL-3:



GEORGE 2-17-8XHW Well SH-2:__

GEORGE 3-17-8XHM Well SH-3:_

TOTAL PROPOSED DISTURBED AREA: 5.33 ACRES

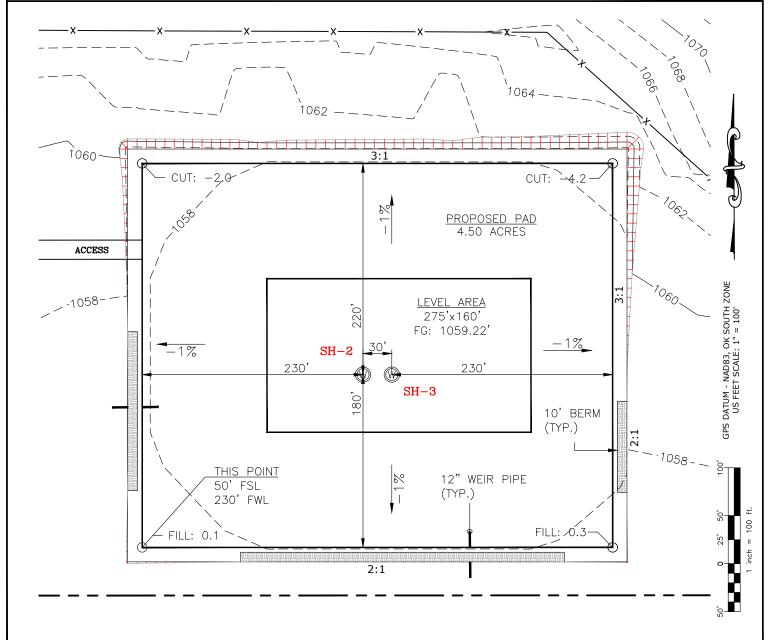

·--1058---

6" OF STRIPPED TOP SOIL: CUT VOLUME 4,303.11 CU. YD. 2974.46 CU. YD. 2970.58 CU. YD. | BERM LENGTH: FILL VOLUME 597' (399.99 CU. YD.)

(CUT/FILL VOLUMES DO NOT INCLUDE 6" OF STRIPPED TOP SOIL)

CURRENT REV.: 1

Prepared



14612 Hertz Quail Springs Pkwy. Oklahoma City, OK 73134

PROPOSED GRADING PLAN

DRAWN BY:	HDG	SCALE:	1" = 100'
CHECKED BY:	MJL	JOB No.:	
APPROVED BY:		DWG. NO.:	PRO-GR.
DATE ISSUED:	11-17-21	SHEET:	4 OF 4

EXHIBIT "A"

TABLE OF QUANTITIES


DISTURBED AREA = 5.33 ACRES ACCESS ROAD = ± 234 '

LOCATED ON THE LANDS OF:

MACK PROPERTIES, LIMITED
PARTNERSHIP

SW/4 SEC 17-6N-6W GRADY COUNTY, OKLAHOMA



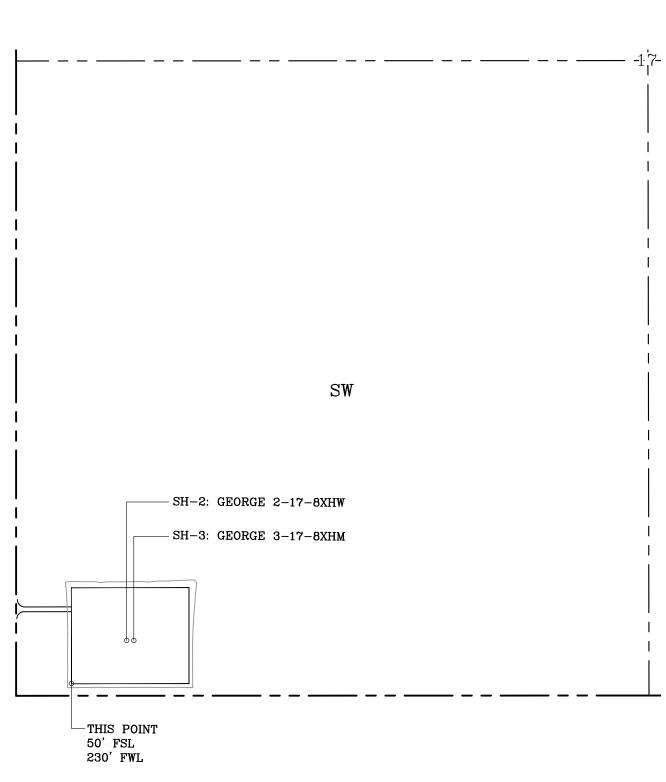

GENERAL NOTES:

- 1. THIS IS NOT A BOUNDARY SURVEY.
- 2. THIS SURVEY DOES NOT GUARANTEE TITLE OR OWNERSHIP.

