API NUMBER: 051 24567 **OKLAHOMA CORPORATION COMMISSION OIL & GAS CONSERVATION DIVISION** P.O. BOX 52000 **OKLAHOMA CITY, OK 73152-2000** (Rule 165:10-3-1)

02/04/2019 Approval Date: Expiration Date: 08/04/2020

Horizontal Hole Multi Unit

Wellhead Protection Area?

Liner not required for Category: C Pit Location is ALLUVIAL Pit Location Formation: ALLUVIUM

Category of Pit: C

is located in a Hydrologically Sensitive Area.

Oil & Gas

				PERMIT TO	<u>DRILL</u>			
ELL LOCATION: Sec: 3	31 Twp: 7N	Rge: 6W	County: GRAI	ΟY				
OT LOCATION: SE	NE SE		M QUARTER: FROM	NORTH FROM	EAST			
		SECTION L	INES:	1657	319			
Lease Name: KATHRYN			Well No:	4-31-6XHS		Well will be	319 feet from near	est unit or lease boundary.
Operator CONTIN Name:	IENTAL RESOUR	CES INC		Telephone:	4052349020; 405234	9	OTC/OCC Number:	3186 0
CONTINENTAL R	ESOURCES II	NC			KATHERII	NE ALICE R	ROBERTS	
PO BOX 269000					816 SEAT	TLE SLEW	COURT	
OKLAHOMA CITY	,	OK 73126-	9000		EDMOND			73025
1 SPRINGER 2 GODDARD 3 4 5 Spacing Orders: 123130			12848 13158 Location Exception	Orders:	6 7 8 9 10	ı	ncreased Density Orders:	
	1810595	-				-	pecial Orders:	
_	1810600					3	pecial Orders.	
	1810601							
	1810602							
	1810603							
Total Depth: 21932	Ground Elev	vation: 1071	Surface (Casing: 840		Depth	to base of Treatable Wat	er-Bearing FM: 590
Under Federal Jurisdiction:	: No		Fresh Water	Supply Well Drill	ed: No		Surface Water	used to Drill: Yes
PIT 1 INFORMATION					Approved Method for o	disposal of Drillin	ng Fluids:	
ype of Pit System: CLOSE	ED Closed System	n Means Steel Pits						
ype of Mud System: WAT	ER BASED				D. One time land application (REQUIRES PERMIT) PERMIT NO: 18-3587			
hlorides Max: 3000 Averag	ge: 2000				H. SEE MEMO			
depth to top of ground wat	-	below base of pit?	Υ	,				
ithin 1 mile of municinal wa	ter well? Y							

PIT 2 INFORMATION

Type of Pit System: CLOSED Closed System Means Steel Pits

Type of Mud System: OIL BASED
Chlorides Max: 300000 Average: 200000

Is depth to top of ground water greater than 10ft below base of pit? Y

Within 1 mile of municipal water well?

Wellhead Protection Area? Y

Pit is located in a Hydrologically Sensitive Area.

Category of Pit: C

Liner not required for Category: C

Pit Location is ALLUVIAL

Pit Location Formation: ALLUVIUM

HORIZONTAL HOLE 1

Sec 06 Twp 6N Rge 6W County **GRADY** SE Spot Location of End Point: SE SW SF Feet From: SOUTH 1/4 Section Line: 50 Feet From: EAST 1/4 Section Line: 880

Depth of Deviation: 12449 Radius of Turn: 382 Direction: 185

Total Length: 8883

Measured Total Depth: 21932

True Vertical Depth: 13550

End Point Location from Lease,
Unit, or Property Line: 50

Notes:

MEMO

Category

HYDRAULIC FRACTURING

Description

1/25/2019 - G71 - OCC 165:10-3-10 REQUIRES:

1) PRIOR TO COMMENCEMENT OF HYDRAULIC FRACTURING OPERATIONS FOR HORIZONTAL WELLS, NOTICE GIVEN FIVE BUSINESS DAYS IN ADVANCE TO OFFSET OPERATORS WITH WELLS COMPLETED IN THE SAME COMMON SOURCE OF SUPPLY WITHIN 1/2 MILE;

2) WITH NOTICE ALSO GIVEN 48 HOURS IN ADVANCE OF HYDRAULIC FRACTURING ALL WELLS TO BOTH THE OCC CENTRAL OFFICE AND LOCAL DISTRICT OFFICES, USING THE "FRAC NOTICE FORM" FOUND AT THE FOLLOWING LINK:

OCCEWEB.COM/OG/OGFORMS.HTML; AND,

3) THE CHEMICAL DISCLOSURE OF HYDRAULIC FRACTURING INGREDIENTS FOR ALL WELLS TO BE REPORTED TO FRACFOCUS WITHIN 60 DAYS AFTER THE CONCLUSION THE HYDRAULIC FRACTURING OPERATIONS, USING THE FOLLOWING LINK: FRACFOCUS.ORG

1/25/2019 - G71 - PITS 1 & 2 - CLOSED SYSTEM=STEEL PITS PER OPERATOR REQUEST, PIT 2 -

OBM RETURNED TO VENDOR, CUTTINGS PERMITTED PER DISTRICT

PENDING CD - 201810595 1/30/2019 - GA8 - (640)(HOR) 6-6N-6W

EST GDRD

COMPL. INT. NCT 660' FB

(COEXIST SP. ORDER # 116468 SPRG)

REC 1/7/2019 (NORRIS)

Category Description

PENDING CD - 201810600 1/30/2019 - GA8 - (I.O.) 31-7N-6W & 6-6N-6W

EST MULTIUNIT HORÍZONTAL WELL

X123130 SPRG 31-7N-6W X201810595 GDRD 6-6N-6W

41% 31-7N-6W 59% 6-6N-6W

CONTINENTAL RESOURCES, INC.

REC 1/7/2019 (NORRIS)

PENDING CD - 201810601 1/30/2019 - GA8 - (I.O.) 31-7N-6W & 6-6N-6W

X123130 SPRG 31-7N-6W X201810595 GDRD 6-6N-6W

X165:10-3-28(C)(2)(B) MAY BE CLOSER THAN 600' TO PHELPS 2-31-30-19XHS **

SHL (31-7N-6W) SE4 NE4

COMPL. INT. (31-7N-6W) NCT 330' FNL, NCT 0' FSL, NCT 660' FWL COMPL. INT. (6-6N-6W) NCT 0' FNL, NCT 150' FSL, NCT 660' FWL

CONTINENTAL RESOURCES, INC.

REC 1/7/2019 (NORRIS)

** S/B: PHELPS 3-31-30-19XHS; TO BE CORRECTED AT HEARING FOR FINAL ORDER PER

OPERATOR

PENDING CD - 201810602 1/30/2019 - GA8 - 31-7N-6W

X123130 SPRG 5 WELLS

CONTINENTAL RESOURCES, INC

REC 1/8/2019 (NORRIS)

PENDING CD - 201810603 1/30/2019 - GA8 - 6-6N-6W

X201810595 GDRD

2 WELLS

CONTINENTAL RESOURCES INC.

REC 1/7/2019 (NORRIS)

PUBLIC WATER SUPPLY WELLS 1/25/2019 - G71 - SKYVIEW TP - 2 PWS/WPA, NW/4 31-7N-6W

SPACING - 123130 1/30/2019 - GA8 - (640) 31-7N-6W

EXT 116468/118211 SPRG, OTHERS

EXHIBIT: A (1 of 3) SHEET: 8.5x14 31 - 7N - 6WSHL: 19-7N-6W BHL-3 6-6N-6W

BHI -4



COVER SHEET

CONTINENTAL RESOURCES, INC.

P.O. BOX 26900 OKLAHOMA CITY, OK 73126 * (T) 1-800-256-8955 (F) 405-234-9253

Well: PHELPS 3-31-30-19XHS Section 31 Township 7N Range 6W I.M.

KATHRYN 4-31-6XHS 35-05124567 GRADY OK County _ _State _ Well: _

CONTINENTAL RESOURCES, INC. Operator _

NAD-83LATITUDE LONGITUDE LATITUDE LONGITUDE NORTHING EASTING POINT WELL NAME W3 PHELPS 3-31-30-19XHS 620981 2008744 1627' FNL / 319' FEL (NE/4 SEC 31) 1069.36 1071.21 LP-3 LANDING POINT 620980 2008183 1627' FNL / 880' FEL (NE/4 SEC 31) 35° 04' 22.54" –97° 52' 02.52 2008187 BHL-3 BOTTOM HOLE LOCATION 633115 50' FNL / 880' FEL (NE/4 SEC 19) --__ W4 KATHRYN 4-31-6XHS 620951 2008744 1657' FNL / 319' FEL (NE/4 SEC 31) 1069.30 1071.21 35° 02' 22.22" -97° 52' 02.76" LP-4 LANDING POINT 620950 2008183 1657' FNL / 880' FEL (NE/4 SEC 31) 50' FSL / 880' FEL (SE/4 SEC 6) BHL-4 BOTTOM HOLE LOCATION 612067 2008196 __ 19-7N-6W:SW4 | TD: 13,000' | 1,320' FSL / 1,620' FWL 2005464 C.W. CHAPMAN #1 629205 19-7N-6W:NE4NW4SE4NW4 | TD: 8,100' | 1,170' FSL / 1,670' FWL 35° 04' 08.53" -97° 52' 34.70' 631694 2005514 X-2BUSER #1-19 --__ 31-7N-6W:SW4SW4NE4 | TD: 3,345' | 330' FSL / 330' FWL x-3J.M. BEAUCHAMP #1 620293 2006754 31-7N-6W:S2N2SW4 | TD: 13,260' | 1,570' FSL / 1,320' FWL 35° 02' 01.87" -97° 52' 39.01' 35.033853 -97.877502 X-4 MOORE "A" #1 618888 2005172 31-7N-6W:SW4SW4 | TD: 12,815' | 660' FSL / 660' FWL 35* 01' 52.86" –97* 52' 46.94" X-5 VOGEL #1 617977 2004514 31-7N-6W:SW4SE4SE4SE4 | TD: 24,467' | 180' FSL / 530' FEL 617508 2008544 KATHRYN #1-31-30XH 6-6N-6W:SW4 | TD: 13,450' | 1,170' FSL / 1,290' FWL 35° 01' 05.51" -97° 52' 39.45' 35.018197 -97.877625 X-7 613190 2005142 MISER #1-6 --6-6N-6W:SW4 | TD: 8,500' | 990' FSL / 660' FWL X-8 613011 2004512 LOWE #1-6 6-6N-6W:NE4SW4SW4SW4 | TD: 13,600' | 495' FSL / 495' FWL 35° 00' 58.85" -97° 52' 49.03" 35.016348 -97.880285 X-9 LOWE #2-6 612516 2004346 --

		NAD-	-27					
POINT	WELL NAME	NORTHING	EASTING	LATITUDE LONGITUDE	LATITUDE LONGITUDE		EXISTING ELEVATION	DESIGN ELEVATION
W3	PHELPS 3-31-30-19XHS	620939	2040341	35° 02′ 22.29" -97° 51′ 54.86"	35.039524 -97.865240	1627' FNL / 319' FEL (NE/4 SEC 31)	1069.36'	1071.21'
LP-3	LANDING POINT	620938	2039780	35° 02' 22.28" -97° 52' 01.61"	35.039522 -97.867114	1627' FNL / 880' FEL (NE/4 SEC 31)		
BHL-3	BOTTOM HOLE LOCATION	633073	2039784	35° 04' 22.31" -97° 52' 01.37"	35.072864 -97.867047	50' FNL / 880' FEL (NE/4 SEC 19)		
W4	KATHRYN 4-31-6XHS	620909	2040341	35° 02' 21.99" -97° 51' 54.86"	35.039442 -97.865240	1657' FNL / 319' FEL (NE/4 SEC 31)	1069.30'	1071.21'
LP-4	LANDING POINT	620908	2039780	35° 02' 21.98" -97° 52' 01.61"	35.039440 -97.867114	1657' FNL / 880' FEL (NE/4 SEC 31)		
BHL-4	BOTTOM HOLE LOCATION	612025	2039793	35° 00' 54.12" -97° 52' 01.60"	35.015034 -97.867111	50' FSL / 880' FEL (SE/4 SEC 6)		
X-1	C.W. CHAPMAN #1	629164	2037061	35° 03' 43.68" -97° 52' 34.19"	35.062132 -97.876163	19-7N-6W:SW4 TD: 13,000' 1,320' FSL / 1,620' FWL		
X-2	BUSER #1-19	631652	2037111	35° 04' 08.29" -97° 52' 33.55"	35.068971 -97.875986	19-7N-6W:NE4NW4SE4NW4 TD: 8,100' 1,170' FSL / 1,670' FWL		
X-3	J.M. BEAUCHAMP #1	620251	2038351	35° 02' 15.51" -97° 52' 18.81"	35.037641 -97.871892	31-7N-6W:SW4SW4NE4 TD: 3,345' 330' FSL / 330' FWL		
X-4	MOORE "A" #1	618847	2036769	35° 02' 01.63" -97° 52' 37.86"	35.033787 -97.877182	31-7N-6W:S2N2SW4 TD: 13,260' 1,570' FSL / 1,320' FWL		
X-5	VOGEL #1	617935	2036110	35° 01' 52.62" -97° 52' 45.79"	35.031284 -97.879385	31-7N-6W:SW4SW4 TD: 12,815' 660' FSL / 660' FWL		
X-6	KATHRYN #1-31-30XH	617466	2040141	35° 01' 47.94" -97° 51' 57.32"	35.029983 -97.865923	31-7N-6W:SW4SE4SE4SE4 TD: 24,467' 180' FSL / 530' FEL		
X-7	MISER #1-6	613149	2036739	35° 01' 05.27" -97° 52' 38.30"	35.018131 -97.877306	6-6N-6W:SW4 TD: 13,450' 1,170' FSL / 1,290' FWL		
X-8	LOWE #1-6	612969	2036108	35° 01' 03.51" -97° 52' 45.88"	35.017641 -97.879411	6-6N-6W:SW4 TD: 8,500' 990' FSL / 660' FWL		-
X-9	LOWE #2-6	612475	2035943	35° 00' 58.61" -97° 52' 47.87"	35.016282 -97.879965	6-6N-6W:NE4SW4SW4SW4 TD: 13,600' 495' FSL / 495' FWL		

Certificate of Authorization No. 7318

Date Staked: 10-26-18 Date Drawn: 10-23-18



Prepared By: Petro Land Services South 10400 Vineyard Blvd. Suite C Oklahoma City, OK 73120

R E	REVISIONS						
No.	DATE	BY	DESCRIPTION	COMMENTS			
00	10-23-18	HDG	ISSUED FOR APPROVAL				
01	10-31-18	HDG	REV'D GRADING TO REFLECT 10,000 YDS. FILL, CHANGED WELL NAME	REVISED ALL EXHIBITS			

EXHIBIT: A (2 of 3)

8.5x14 SHFFT:


31-7N-6W SHL: 19-7N-6W BHL-3

PETRO LAND SERVICES SOUTH, L 10400 VINEYARD BLVD. SUITE C, OKLA. CITY, OKLA. 73120 * OFFICE (405) 212-3108 Certificate of Authorization No. 7318

GRADY County Oklahoma 1627' FNL-319' FEL Section 31 Township $\frac{7N}{}$ Range $\frac{6W}{}$ I.M.



CONTINENTAL RESOURCES, INC (OPERATOR)

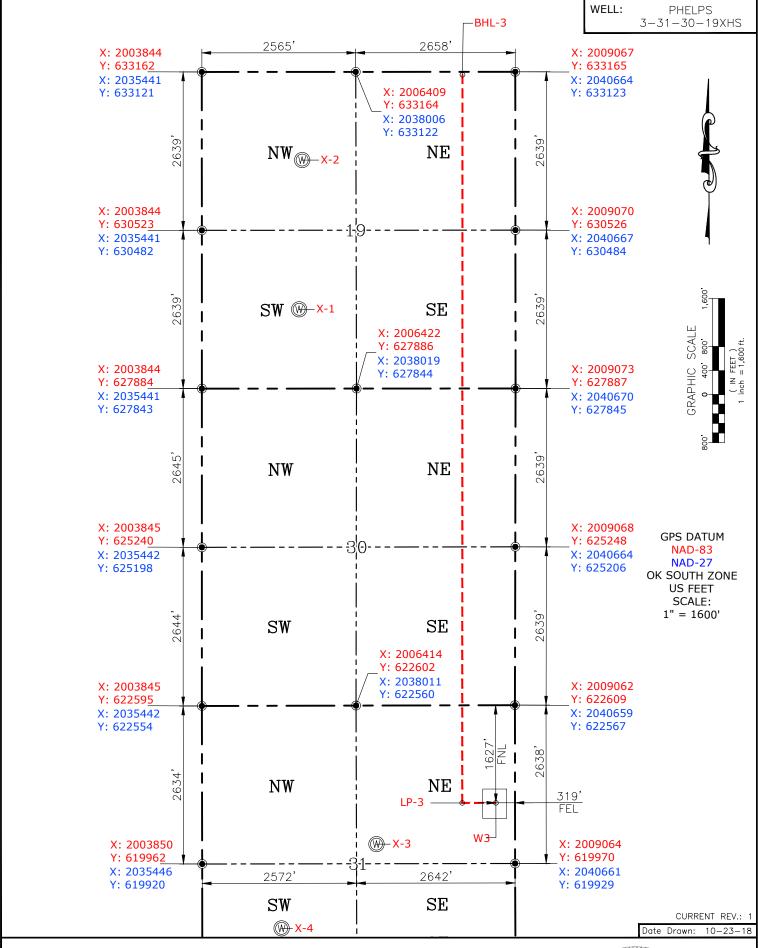

Please note that this location was staked on the ground under the supervision of a Licensed Professional Land Surveyor, but the accuracy of this survey is not guaranteed. Please contact PLS promptly if any inconsistency is determined. GPS data is observed from RTK-GPS. NOTE: X and Y data shown hereon for Section Corners may NOT have been surveyed on-the-ground, and further, does NOT represent a true Boundary Survey. Quarter Section distances may be assumed from a Government Survey Plat or assumed at a proportionate distance from opposing section corners, or occupation thereof, and may not have been measured on-the-ground, and further, does not represent a true Boundary Survey.

CERTIFICATE:

I, RANDALL J. BILYEU an Oklahoma Licensed Land Surveyor and an authorized agent of Petro Land Services South, LLC, do hereby certify to the information shown herein.



Oklahoma PLS No.1196 DATE

EXHIBIT: A (3 of 3)

8.5x14 SHFFT:


31 - 7N - 6WSHL: 6-6N-6W BHI-4

PETRO LAND SERVICES SOUTH, L 10400 VINEYARD BLVD. SUITE C, OKLA. CITY, OKLA. 73120 * OFFICE (405) 212-3108 Certificate of Authorization No. 7318



CONTINENTAL RESOURCES, INC (OPERATOR)

GRADY County Oklahoma 1657' FNL-319' FEL Section 31 Township $\frac{7N}{}$ Range $\frac{6W}{}$ I.M.

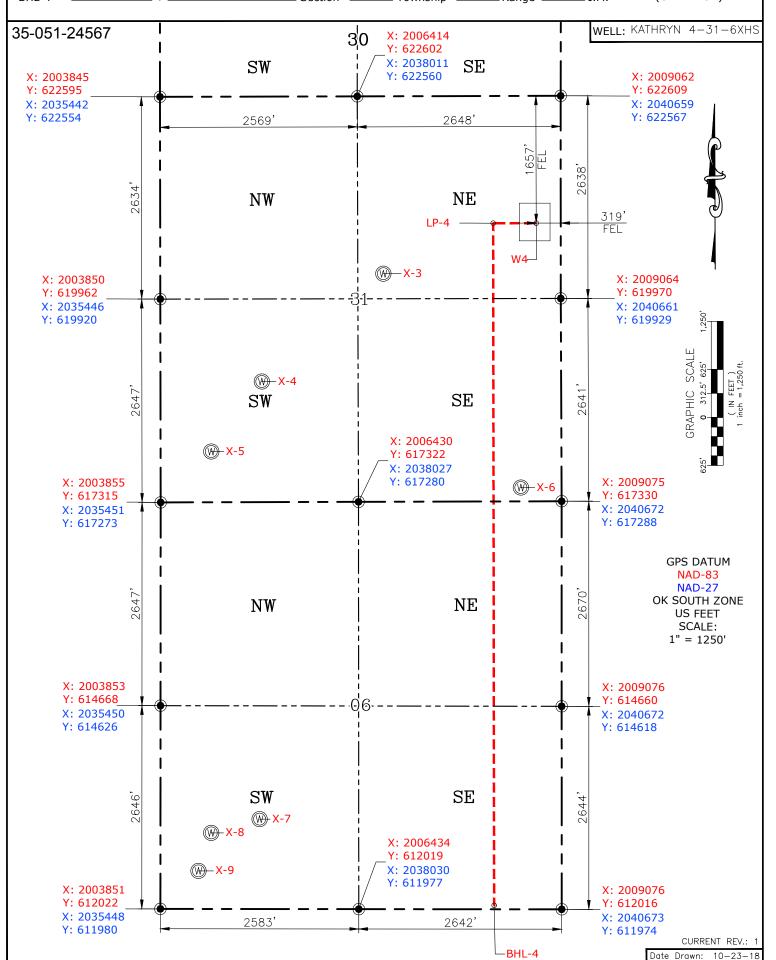

Please note that this location was staked on the ground under the supervision of a Licensed Professional Land Surveyor, but the accuracy of this survey is not guaranteed. Please contact PLS promptly if any inconsistency is determined. GPS data is observed from RTK-GPS. NOTE: X and Y data shown hereon for Section Corners may NOT have been surveyed on-the-ground, and further, does NOT represent a true Boundary Survey. Quarter Section distances may be assumed from a Government Survey Plat or assumed at a proportionate distance from opposing section corners, or occupation thereof, and may not have been measured on-the-ground, and further, does not represent a true Boundary Survey.

CERTIFICATE:

I, RANDALL J. BILYEU an Oklahoma Licensed Land Surveyor and an authorized agent of Petro Land Services South, LLC, do hereby certify to the information shown herein.



Oklahoma PLS No.1196 DATE EXHIBIT: _____B

SHEET: 8.5x11

SHL: 31-7N-6WBHL-3 19-7N-6W

BHL-4 6-6N-6W


PETRO LAND SERVICES SOUTH, LLC

10400 VINEYARD BLVD. SUITE C, OKLA. CITY, OKLA. 73120 * OFFICE (405) 212-3108 Certificate of Authorization No. 7318

<u>W3:1627' FNL-319' FEL</u> GRADY County Oklahoma <u>W4:1657' FNL-319' FEL</u> Section <u>31</u> Township <u>7N</u> Range <u>6W</u> I.M.



CONTINENTAL RESOURCES,INC (OPERATOR)

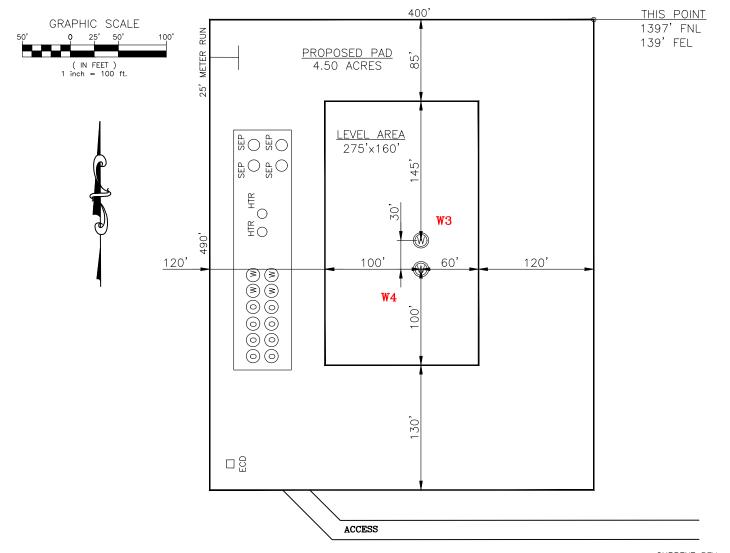

CURRENT REV.: 1

W3: PHELPS 3-31-30-19XHS W4: KATH	IRYN 4-31-6XHS
-----------------------------------	----------------

DATUM: NAD-83 DATUM: NAD-83

LAT: <u>35°02'22.52"</u> LAT: <u>35°02'22.23"</u>

LONG: <u>-97°51′56.01"</u> LONG: <u>-97°51′56.01"</u>
LAT: 35.039590° LAT: 35.039508°

LONG: <u>-97.865559</u> LONG: <u>-97.865559</u>°

STATE PLANE

STATE PLANE COORDINATES

COORDINATES
(US FEET): OK SOUTH (US FEET): OK SOUTH

X: <u>2008744</u> X: <u>2008744</u> Y: <u>620981</u> Y: <u>620951</u> Operator: CONTINENTAL RESOURCES, INC.

Reference Stakes or Alternate Location Stakes Set:

Therefore Stakes of Allerhate Escation Stakes Set.

Best Accessibility to Location: From The East Line

Distance & Direction From Hwy. or Town: Leaving Chickasha, head east on SH-9 for 4.25 miles & turn right on Maple Rd. Head south for 0.35 miles to the proposed access road along the west side of Maple Rd.

THE INFORMATION SHOWN HEREIN IS FOR CONSTRUCTION PURPOSES ONLY

Well W3: PHELPS 3-31-30-19XHS
Wall W4: KATHRYN 4-31-6XHS

This Information Was Gathered With a GPS Receiver With ± 1 Foot Horiz./Vert. Accuracy

LANDING POINT, BOTTOM HOLE AND DRILL PATH INFORMATION PROVIDED BY OPERATOR LISTED, NOT SURVEYED.



Prepared By: Petro Land Services South 10400 Vineyard Blvd. Suite C Oklahoma City, OK 73120

Certificate of Authorization No. 7318


EXHIBIT: _____C

SHEET: ____8.5×11


SHL: 31-7N-6W

BHL-3 19-7N-6W 6-6N-6W



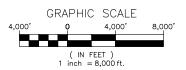

VICINITY MAP

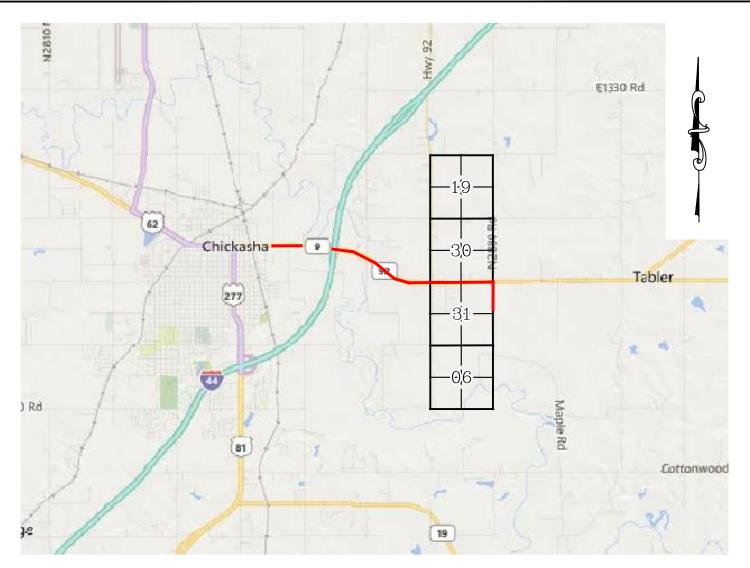

LEAVING CHICKASHA, HEAD EAST ON SH-9 FOR 4.25 MILES & TURN RIGHT ON MAPLE RD. HEAD SOUTH FOR 0.35 MILES TO THE PROPOSED ACCESS ROAD ALONG THE WEST SIDE OF MAPLE RD.

CONTINENTAL RESOURCES, INC.

P.O. BOX 26900 OKLAHOMA CITY, OK 73126 * (T) 1-800-256-8955 (F) 405-234-9253

 Certificate of Authorization No. 7318
 Section
 31 Township
 7N Range
 6W I.M.
 Well W3: PHELPS 3-31-30-19XHS

 County
 GRADY
 State
 OK
 Well W4: KATHRYN 4-31-6XHS

Operator CONTINENTAL RESOURCES, INC.



Prepared By: Open Petro Land Services South 10400 Vineyard Blvd. Suite C Oklahoma City, OK 73120 EXHIBIT: _____D

SHEET: 8.5x11

SHL: $\frac{31-7N-6W}{19-7N-6W}$

BHL-3 $\frac{19-7N-6W}{6-6N-6W}$



WELL W3: PHELPS 3-31-30-19XHS
WELL W4: KATHRYN 4-31-6XHS

FACING NORTH



FACING SOUTH



CURRENT REV.: 1



Prepared By: Petro Land Services South 10400 Vineyard Blvd. Suite C Oklahoma City, OK 73120

TERRAIN

DRAWN BY:	HDG	SCALE:	N.T.S.
CHECKED BY:	MJL	JOB No.:	
APPROVED BY:		DWG. NO.:	TERRAIN-1
DATE ISSUED:	10-23-18	SHEET:	1 OF 2

EXHIBIT: ____E

SHEET: 8.5x11

SHL: 31-7N-6WBHL-3 19-7N-6W

BHL-4 6-6N-6W



WELL W3: PHELPS 3-31-30-19XHS
WELL W4: KATHRYN 4-31-6XHS

FACING EAST



FACING WEST



CURRENT REV.: 1



Prepared By: Petro Land Services South 10400 Vineyard Blvd. Suite C Oklahoma City, OK 73120

TERRAIN

DRAWN BY:	HDG	SCALE:	N.T.S.
CHECKED BY:	MJL	JOB No.:	
APPROVED BY:		DWG. NO.:	TERRAIN-2
DATE ISSUED:	10-23-18	SHEET:	2 OF 2

EXHIBIT: ____F

SHEET: 8.5x11


SHL: $\frac{31-7N-6W}{19-7N-6W}$

BHL-4 6-6N-6W




WELL W3: PHELPS 3-31-30-19XHS
WELL W4: KATHRYN 4-31-6XHS

PROPOSED ACCESS ROAD = 467' | 28.30 RODS (TOTAL)

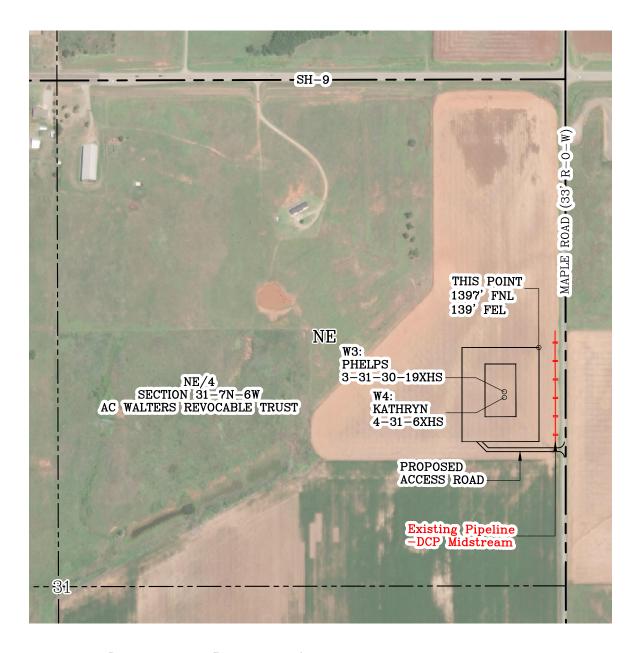

Section 31 Township 7N Range 6W I.M. County 9RADY State 9RADY State

Operator CONTINENTAL RESOURCES, INC.

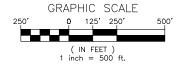

CURRENT REV.: 1



Prepared By: Petro Land Services South 10400 Vineyard Blvd. Suite C Oklahoma City, OK 73120

AERIAL PLAT

DRAWN BY:	HDG	SCALE:	1" = 500'
CHECKED BY:	MJL	JOB No.:	
APPROVED BY:		DWG. NO.:	AERIAL—1
DATE ISSUED:	10-23-18	SHEET:	1 OF 4

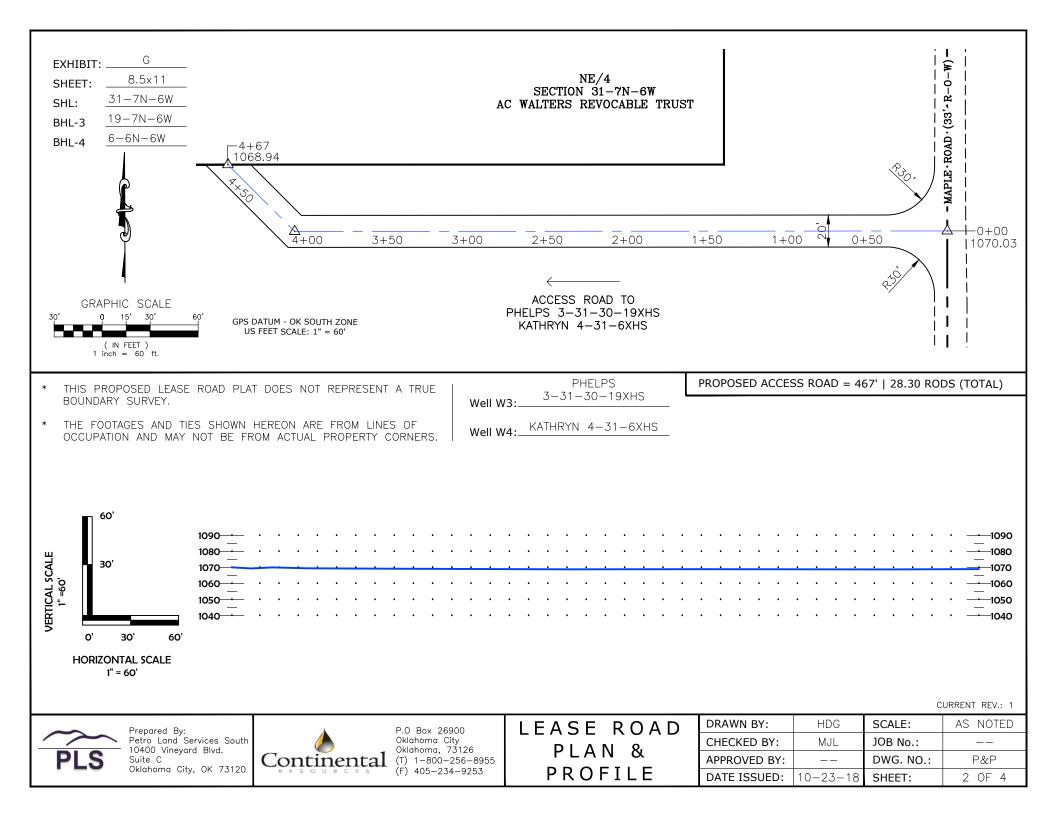


EXHIBIT: H

SHEET: 8.5x11

SHL: 31-7N-6W

BHL-3 19-7N-6W

BHL-4 6-6N-6W




WELL W3: PHELPS 3-31-30-19XHS

WELL W4: KATHRYN 4-31-6XHS

GRAPHIC SCALE

50' 0 25' 50' 100'

(IN FEET)
1 inch = 100 ft.

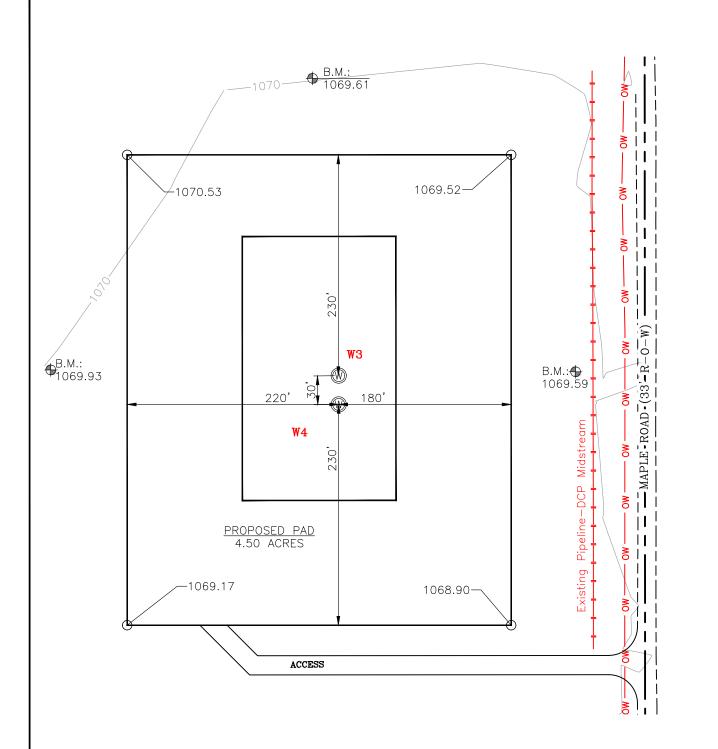



CURRENT REV.: 1



Prepared By: Petro Land Services South 10400 Vineyard Blvd. Suite C Oklahoma City, OK 73120 EXISTING GRADING PLAN

DRAWN BY:	HDG	SCALE:	1" = 100'
CHECKED BY:	MJL	JOB No.:	
APPROVED BY:		DWG. NO.:	EX-GR.
DATE ISSUED:	10-23-18	SHEET:	3 OF 4

BHL-4

6-6N-6W




WELL W3: PHELPS 3-31-30-19XHS
WELL W4: KATHRYN 4-31-6XHS

GRAPHIC SCALE

50' 0 25' 50' 100'

(IN FEET)
1 inch = 100 ft.

TOTAL PROPOSED DISTURBED AREA: 5.18 ACRES

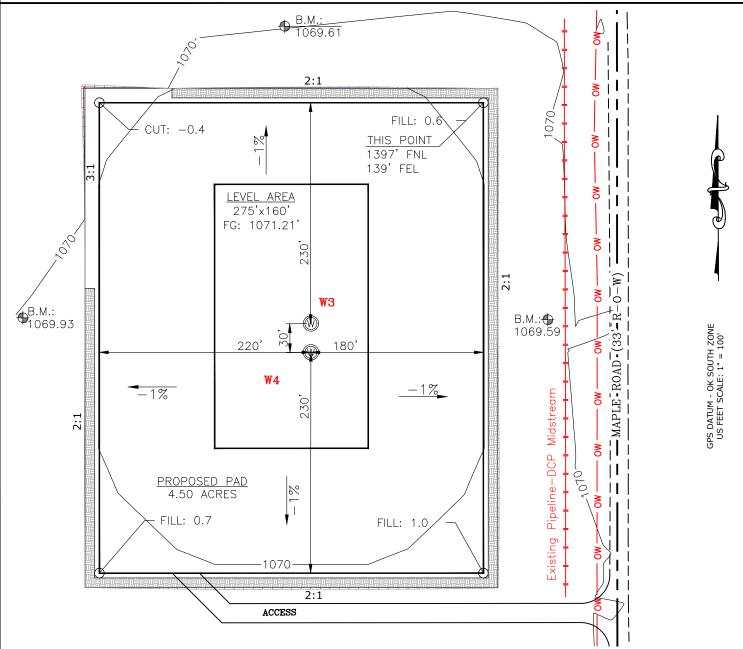

10,000 CU. YDS. OF FILL PROVIDED FROM PHELPS KATHRYN 2

CUT VOLUME 4194.68 CU. YD. 6" OF STRIPPED TOP SOIL: 4,175.09 CU. YD.

FILL VOLUME 14195.23 CU. YD. | BERM LENGTH: 1,571" (1052.57 CU. YD.)

(CUT/FILL VOLUMES INCLUDE 6" OF STRIPPED TOP SOIL)

CURRENT REV.: 1



Prepared By: Petro Land Services South 10400 Vineyard Blvd. Suite C Oklahoma City, OK 73120 PROPOSED GRADING PLAN

DRAWN BY:	HDG	SCALE:	1" = 100'
CHECKED BY:	MJL	JOB No.:	
APPROVED BY:		DWG. NO.:	PRO-GR.
DATE ISSUED:	10-23-18	SHEET:	4 OF 4