API NUMBER: 011 24303

OKLAHOMA CORPORATION COMMISSION OIL & GAS CONSERVATION DIVISION P.O. BOX 52000 OKLAHOMA CITY, OK 73152-2000 (Rule 165:10-3-1)

Approval Date:	02/03/2022
Expiration Date:	08/03/2023

Multi Unit Oil & Gas

PERMIT TO DRILL

WELL LOCATION:	Section: 06	Township	o: 14N R:	ange: 13W	County: I	BLAINE				
SPOT LOCATION:	NW NE	NW NW	FEET FROM QU		NORTH	FROM WEST				
			SECTION		300	980				
Lease Name:	B PERKINS				: 2-6-7-18)		Well will be	300 feet fro	m nearest unit or leas	so boundary
				Well No	. 2-0-7-107	KTIWI	well will be			•
Operator Name:	CONTINENTAL	RESOURCES INC	;	Telephone	40523497	797; 4052349000;		01	C/OCC Number:	3186 0
CONTINENT	AL RESOURC	ES INC				SCOTT PERKI	NS FARMS LL	С		
	PO BOX 268870 C/O BRAD PERKINS									
OKLAHOMA CITY, OK 73126-8870 90560 N 2450 ROAD										
ORLAHOWA	OII I,	OK	73120 007	O		THOMAS	NOAD	OK	73669	
						I I I I I I I I I I I I I I I I I I I I		OK	73009	
Formation(s)	(Permit Valid	I for Listed Fo	rmations Onl	y):						
Name		Cod	е	Depth						
1 MISSISSIPF			MSSP	12821						
	PIAN (LESS CHEST	TER) 359N	MSNLC	12950						
Spacing Orders:	668480			Location Exce	ption Order	s: No Exception	ns	Increased D	ensity Orders: No	Density
	664508 665202									
			•					s	pecial Orders: No	Special
Pending CD Numb				Working in	terest owne	rs' notified: ***			140	Орсска
	202200262									
Total Depth: 2	28085 G	round Elevation:	1641	Surface	Casing:	1500	Depth to	o base of Treatab	le Water-Bearing FM:	40
								Deep su	rface casing has	been approved
Under	Federal Jurisdictio	n: No				Approved Method fo	or disposal of Drilli	ng Fluids:		
	r Supply Well Drille					D. One time land app	lication (REQUIR	ES PERMIT)	PERMIT NO): 21-38008
Surface	e Water used to Dri	II: Yes				H. (Other)		SEE MEMO		
PIT 1 INFOR	MATION					Catego	ry of Pit: C			
	Pit System: CLOS	SED Closed Syst	em Means Steel I	Pits		Liner not required				
Type of M	lud System: WAT	ER BASED				Pit Loc	ation is: BED AQ	UIFER		
Chlorides Max: 80	000 Average: 5000					Pit Location Fo	rmation: RUSH S	PRINGS		
Is depth to	top of ground wate	r greater than 10ft	below base of pi	? Y						
Within 1	mile of municipal w									
Pit is lo	Wellhead Protect		roo							
Pit <u>is</u> lo	ocated in a Hydrolo	gically Selisitive A	iica.							
PIT 2 INFOR						_	ry of Pit: C			
	Pit System: CLOS		em Means Steel I	Pits		Liner not required		LUEED		
	lud System: OIL B 00000 Average: 20						ation is: BED AQ rmation: RUSH S			
	•	5550				Location Fo				
	,	r greater than 10ft	below base of ni	t? Y			mation. Roome	T KIIVOO		
Within 1	mile of municipal w	r greater than 10ft ater well? N	below base of pi	1? Y			maion. Roome	KINGO		
Within 1	mile of municipal was	ater well? N	below base of pi	1? Y			THE STATE OF THE S	i Kiivee		

MULTI UNIT HOLE 1

Section: 18 Township: 14N Range: 13W Meridian: IM Total Length: 14883

> County: BLAINE Measured Total Depth: 28085

> > True Vertical Depth: 13599

Spot Location of End Point: SE SE SW SW

> Feet From: SOUTH 1/4 Section Line: 50 End Point Location from Lease, Unit, or Property Line: 50 1/4 Section Line: 1300 Feet From: WEST

NOTES:	
Category	Description
DEEP SURFACE CASING	[2/2/2022 - GC2] - APPROVED; NOTIFY OCC FIELD INSPECTOR IMMEDIATELY OF ANY LOSS OF CIRCULATION OR FAILURE TO CIRCULATE CEMENT TO SURFACE ON ANY CONDUCTOR OR SURFACE CASING
HYDRAULIC FRACTURING	[2/2/2022 - GC2] - OCC 165:10-3-10 REQUIRES:
	1) NOTICE SHALL BE GIVEN AT LEAST 5 BUSINESS DAYS PRIOR TO COMMENCEMENT OF HYDRAULIC FRACTURING OPERATIONS ON A HORIZONTAL WELL TO OPERATORS PRODUCING WELLS WITHIN 1 MILE OF THE COMPLETION INTERVAL OF THE SUBJECT WELL. THE NOTICE TO SUCH OPERATORS SHALL CONTAIN THE INFORMATION IN FORM 6000NOO. IF THE HYDRAULIC FRACTURING OPERATIONS SCHEDULE CHANGES AFTER NOTICE HAS BEEN PROVIDED, RESULTING IN A DELAY OF OPERATIONS OF MORE THAN 5 DAYS FROM THE INITIAL NOTICE, NEW NOTICE IS REQUIRED TO BE GIVEN;
	2) NOTICE WILL BE GIVEN TO THE OCC CENTRAL OFFICE AND LOCAL DISTRICT OFFICES AT LEAST 48 HOURS PRIOR TO COMMENCEMENT OF HYDRAULIC FRACTURING OPERATIONS. FORM 6000NHF SHALL BE USED AND IS FOUND AT THIS LINK: OCCEWEB.COM/OG/OGFORMS.HTML; AND,
	3) THE CHEMICAL DISCLOSURE OF HYDRAULIC FRACTURING INGREDIENTS FOR ALL WELLS IS TO BE REPORTED TO FRACFOCUS WITHIN 60 DAYS AFTER THE CONCLUSION OF HYDRAULIC FRACTURING OPERATIONS, FOUND AT FRACFOCUS.ORG
МЕМО	[2/2/2022 - GC2] - CLOSED SYSTEM=STEEL PITS PER OPERATOR REQUEST, OBM RETURNED TO VENDOR, CUTTINGS PERMITTED PER DISTRICT
PENDING CD - 202200261	[2/2/2022 - G56] - (E.O.) 6, 7 & 18-14N-13W X668480 MSNLC 6-14N-13W X665202 MSSP 7-14N-13W X664508 MSSP 18-14N-13W COMPL INT (6-14N-13W) NCT 150' FNL, NCT 0' FSL, NCT 990' FWL COMPL INT (7-14N-13W) NCT 0' FNL, NCT 0' FSL, NCT 990' FWL COMPL INT (18-14N-13W) NCT 0' FNL, NCT 150' FSL, NCT 990' FWL NO OP NAMED REC 2/1/2022 (MILLER)
PENDING CD - 202200262	[2/2/2022 - G56] - (E.O.) 6, 7 & 18-14N-13W EST MULTIUNIT HORIZONTAL WELL X668480 MSNLC 6-14N-13W X665202 MSSP 7-14N-13W X664508 MSSP 18-14N-13W 33% 6-14N-13W 34% 7-14N-13W 33% 18-14N-13W NO OP NAMED REC 2/1/2022 (MILLER)
SPACING - 664508	[2/2/2022 - G56] - (640) 18-14N-13W VAC 94272 MSCST EST MSSP, OTHER
SPACING - 665202	[2/2/2022 - G56] - (640) 7-14N-13W VAC 94272 MSCST EST MSSP, OTHER
SPACING - 668480	[2/2/2022 - G56] - (640)(HOR) 6-14N-13W EXT OTHER EST MSNLC COMPL INT NLT 660' FB

EXHIBIT: <u>A (1 of 3)</u> SHEET: 8.5x11 SHL: <u>6-14N-13W</u> BHL-2: <u>18-14</u>N-13W



WELL PAD ID: 3AA942CD-086C-38A3-3786-6F5B05D47643

SH-2-ID: T5IFMT9CF6

COVER SHEET

CONTINENTAL RESOURCES, INC. P.O. BOX 26900 OKLAHOMA CITY, OK 73126 * (T) 1-800-256-8955 (F) 405-234-9253

Section 6 Township 14N Range 13W I.M. SH-2: B PERKINS 2-6-7-18XHM

County _____State ___OK___

Operator _____CONTINENTAL RESOURCES, INC.

		NAD-	-83					
POINT	WELL NAME	NORTHING	EASTING	LATITUDE LONGITUDE	LATITUDE LONGITUDE		EXISTING ELEVATION	DESIGN ELEVATION
SH-2	B PERKINS 2-6-7-18XHM	264292	1781882	35° 43′ 27.77″ -98° 37′ 43.35″	35.724381 -98.628708	300' FNL / 980' FWL (NE/4 NE/4 NW/4 NW/4 SEC 6)	1640.52	1641.63'
LP-2	LANDING POINT	264290	1782202	35° 43′ 27.78″ -98° 37′ 39.47″	35.724383 -98.627630	300' FNL / 1300' FWL (NW/4 SEC 6)		
BHL-2	BOTTOM HOLE LOCATION	248868	1782065	35° 40′ 55.25″ -98° 37′ 39.92″	35.682014 -98.627755	50' FSL / 1300' FWL (SW/4 SEC 18)		
X-1	LAPEL #1-6	259974	1781515	35° 42' 45.05" -98° 37' 47.45"	35.712513 -98.629848	6-14N-13W: TD: 10387' 660' FSL / 660' FWL		
X-2	RENEE #1-6	260629	1784783	35° 42′ 51.74″ -98° 37′ 07.88″	35.714372 -98.618855	6-14N-13W: TD: 10550' 1320' FSL / 1299' FEL		
X-3	LLOYD SCOTT #1	263096	1782134	35° 43' 15.96" -98° 37' 40.20"	35.721101 -98.627832	6-14N-13W: TD: 11931' 1494' FNL / 1245' FWL		
X-4	SCOTT #1-6	263934	1781888	35° 43′ 24.23″ -98° 37′ 43.25″	35.723397 -98.628679	6-14N-13W: TD: 11900' 658' FNL / 990' FWL		
X-5	LAPEL #1	263928	1784796	35° 43′ 24.36″ -98° 37′ 07.97″	35.723434 -98.618881	6-14N-13W: TD: 11550' 652' FNL / 1312' FEL		
X-6	EDDIE #1-17	258008	1782158	35° 42' 25.64" -98° 37' 39.51"	35.707123 -98.627641	7-14N-13W: TD: 10610' 1306' FNL / 1320' FWL		
X-7	PERKINS #1	254721	1781770	35° 41′ 53.12″ -98° 37′ 43.95″	35.698088 -98.628874	7-14N-13W: TD: 10650' 660' FSL / 959' FWL		
X-8	PERKINS #2	255381	1784737	35° 41' 59.83" -98° 37' 08.03"	35.699953 -98.618896	7-14N-13W: TD: 11870' 1320' FSL / 1304' FEL		
X-9	NICHOLS #1	258007	1784894	35° 42′ 25.81″ -98° 37′ 06.33″	35.707170 -98.618424	7-14N-13W: TD: 11930' 1302' FNL / 1167' FEL		
X-10	B PERKINS #1-7-18XH	259034	1781426	35° 42' 35.75" -98° 37' 48.46"	35.709930 -98.630129	7-14N-13W: TD: 23933' 280' FNL / 580' FWL		
X-11	AUSTIN FANSLER # 3-18	252229	1783863	35° 41′ 28.60″ -98° 37′ 18.38″	35.691278 -98.621774	18-14N-13W: TD: 10600' 1832' FNL / 2155' FEL		
X-12	SWITZER, BEULAH #3-18	251208	1782103	35° 41′ 18.39" -98° 37′ 39.63"	35.688442 -98.627676	18-14N-13W: TD: 11000' 2390' FSL / 1320' FWL		
X-13	BEULAH SWITZER #1	250138	1782095	35° 41′ 07.81″ -98° 37′ 39.65″	35.685503 -98.627681	18-14N-13W: TD: 10699' 1320' FSL / 1320' FWL		
X-14	BEULAH SWITZER #4-18	253420	1781791	35° 41′ 40.25″ -98° 37′ 43.59″	35.694514 -98.628776	18-14N-13W: TD: 11000' 641' FNL / 990' FWL		
X-15	BEULAH SWITZER #2	252260	1782112	35* 41' 28.80" -98* 37' 39.61"	35.691333 -98.627671	18-14N-13W: TD: 10620' 1801' FNL / 1320' FWL		

Certificate of Authorization No. 7318



Prepared By: PSLS 14612 Bogert Parkway Oklahoma City, OK 73134

	REVISIONS										
	No.	DATE	STAKED	BY	DESCRIPTION	COMMENTS					
	00	01-13-22	**-**-22	HDG	ISSUED FOR APPROVAL						
1											

EXHIBIT: A (2 of 3)

SHEET: 8.5×11 SHL: $6-14 \times 13 \times 14$ BHL-2: $18-14 \times 13 \times 14$



WELL PAD ID: 3AA942CD-086C-38A3-3786-6F5B05D47643

SH-2-ID: T5IFMT9CF6

COVER SHEET CONTINUED...

CONTINENTAL RESOURCES, INC.

P.O. BOX 26900 OKLAHOMA CITY, OK 73126 * (T) 1-800-256-8955 (F) 405-234-9253

 Section
 6
 Township
 14N
 Range
 13W
 I.M.
 SH-2:
 B PERKINS
 2-6-7-18XHM

 County
 BLAINE
 State
 OK

Operator _____CONTINENTAL RESOURCES, INC.

NAD-27								
POINT	WELL NAME	NORTHING	EASTING	LATITUDE LONGITUDE	LATITUDE LONGITUDE		EXISTING ELEVATION	DESIGN ELEVATION
SH-2	B PERKINS 2-6-7-18XHM	264266	1813483	35° 43′ 27.60″ -98° 37′ 42.07″	35.724333 -98.628352	300' FNL / 980' FWL (NE/4 NE/4 NW/4 NW/4 SEC 6)	1640.52'	1641.63'
LP-2	LANDING POINT	264265	1813803	35° 43' 27.60" -98° 37' 38.18"	35.724334 -98.627274	300' FNL / 1300' FWL (NW/4 SEC 6)		
BHL-2	BOTTOM HOLE LOCATION	248843	1813666	35° 40′ 55.07" -98° 37′ 38.64"	35.681965 -98.627400	50' FSL / 1300' FWL (SW/4 SEC 18)		
X-1	LAPEL #1-6	259949	1813116	35° 42' 44.87" -98° 37' 46.17"	35.712465 -98.629492	6-14N-13W: TD: 10387' 660' FSL / 660' FWL		
X-2	RENEE #1-6	260604	1816384	35° 42′ 51.56″ -98° 37′ 06.60″	35.714323 -98.618500	6-14N-13W: TD: 10550' 1320' FSL / 1299' FEL		
X-3	LLOYD SCOTT #1	263071	1813735	35° 43′ 15.79″ -98° 37′ 38.91″	35.721053 -98.627476	6-14N-13W: TD: 11931' 1494' FNL / 1245' FWL		
X-4	SCOTT #1-6	263908	1813489	35° 43′ 24.06″ -98° 37′ 41.96″	35.723349 -98.628323	6-14N-13W: TD: 11900' 658' FNL / 990' FWL		
X-5	LAPEL #1	263903	1816397	35° 43′ 24.19″ -98° 37′ 06.69″	35.723386 -98.618525	6-14N-13W: TD: 11550' 652' FNL / 1312' FEL		
X-6	EDDIE #1-17	257983	1813759	35° 42' 25.47" -98° 37' 38.23"	35.707075 -98.627286	7-14N-13W: TD: 10610' 1306' FNL / 1320' FWL		
X-7	PERKINS #1	254696	1813371	35° 41' 52.94" -98° 37' 42.67"	35.698039 -98.628519	7-14N-13W: TD: 10650' 660' FSL / 959' FWL		
X-8	PERKINS #2	255356	1816338	35° 41' 59.65" -98° 37' 06.75"	35.699904 -98.618541	7-14N-13W: TD: 11870' 1320' FSL / 1304' FEL		
X-9	NICHOLS #1	257982	1816495	35° 42' 25.64" -98° 37' 05.05"	35.707122 -98.618069	7-14N-13W: TD: 11930' 1302' FNL / 1167' FEL		
X-10	B PERKINS #1-7-18XH	259009	1813027	35° 42' 35.57" -98° 37' 47.18"	35.709881 -98.629773	7-14N-13W: TD: 23933' 280' FNL / 580' FWL		
X-11	AUSTIN FANSLER # 3-18	252204	1815464	35° 41' 28.43" -98° 37' 17.11"	35.691229 -98.621419	18-14N-13W: TD: 10600' 1832' FNL / 2155' FEL		
X-12	SWITZER, BEULAH #3-18	251183	1813704	35* 41' 18.22" -98* 37' 38.36"	35.688394 -98.627321	18-14N-13W: TD: 11000' 2390' FSL / 1320' FWL		
X-13	BEULAH SWITZER #1	250113	1813696	35° 41' 07.63" -98° 37' 38.38"	35.685454 -98.627326	18-14N-13W: TD: 10699' 1320' FSL / 1320' FWL		
X-14	BEULAH SWITZER #4-18	253395	1813392	35* 41' 40.07" -98* 37' 42.32"	35.694465 -98.628421	18-14N-13W: TD: 11000' 641' FNL / 990' FWL		
X-15	BEULAH SWITZER #2	252235	1813713	35° 41' 28.62" -98° 37' 38.34"	35.691284 -98.627316	18-14N-13W: TD: 10620' 1801' FNL / 1320' FWL		

PETRO LAND SERVICES SOUTH, LLC

14612 BOGERT PARKWAY, OKLA. CITY, OKLA. 73134 * OFFICE (405) 212-3108


Continental

CONTINENTAL RESOURCES,INC (OPERATOR)

EXHIBIT: <u>A (3 of 3)</u> 8.5x14 SHEET: 6-14N-13W SHL: 18-14N-13W BHL-2:

BLAINE _ County Oklahoma 300' FNL-980' FWL Section 6 $\frac{14N}{}$ Range $\frac{13W}{}$ I.M. _ Township

> WELL: B PERKINS 2-6-7-18XHM

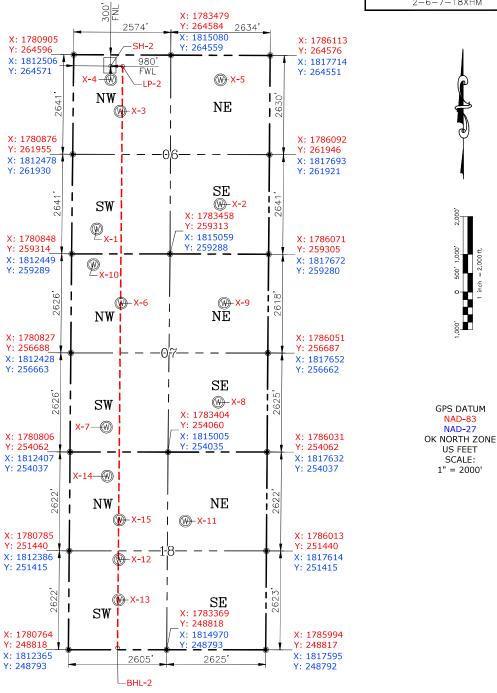

Please note that this location was staked on the ground under the supervision of a Licensed Professional Land Surveyor, but the accuracy of this survey is not guaranteed. Please contact PLS promptly if any inconsistency is determined. GPS data is observed from RTK-GPS. NOTE: X and Y data shown hereon for Section Corners may NOT have been surveyed on-the-ground, and further, does NOT represent a true Boundary Survey. Quarter Section distances may be assumed from a Government Survey Plat or assumed at a proportionate distance from opposing section corners, or occupation thereof, and may not have been measured on-the-ground, and further, does not represent a true Boundary Survey.

CERTIFICATE:

I, FRED A. SELENSKY, an Oklahoma Licensed Land Surveyor and an authorized agent of Petro Land Services South, LLC, do hereby certify to the information shown herein.

Date Drawn: 01-13-22 SIONAL Fred A. Selensky 1860

-/3-22 Oklahoma PLS No.1860

DATE

CURRENT REV.: 0

EXHIBIT: _____B

SHEET: 8.5×11

SHL: $\frac{6-14N-13W}{18-14N-13W}$

PETRO LAND SERVICES SOUTH, LLC

14612 BOGERT PARKWAY, OKLA. CITY, OKLA. 73134 * OFFICE (405) 212-3108 Certificate of Authorization No. 7318




CONTINENTAL RESOURCES,INC (OPERATOR)

100

BLAINE County Oklahoma

300' FNL-980' FWL Section 6 Township 14N Range 13W I.M.

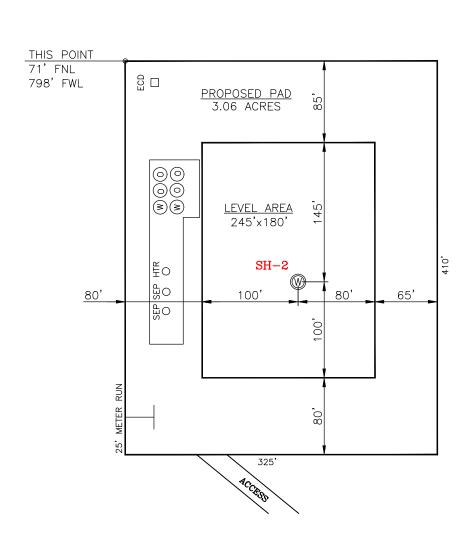



1 inch = 100 ft.

CURRENT REV.: 0

SH-2: B PERKINS 2-6-7-18XHM

DATUM: NAD-83

NORTHING: 264292

EASTING: <u>1781882</u>

LAT: N35°43'27.77"

LONG: <u>W98°37'43.35"</u>

LAT: 35.724381°

LONG: -98.628708°

STATE PLANE COORDINATES

(US FEET): NORTH

This Information Was Gathered With a GPS Receiver With ±1 Foot Horiz./Vert. Accuracy

Operator: CONTINENTAL RESOURCES, INC.

Lease Name: ____

Topography & Vegetation: Pasture

Good Drill Site? Yes Reference Stakes or Alternate Location Stakes Set: No

Best Accessibility to Location: From The West Line

Distance & Direction From Hwy. or Town: Leaving Thomas, head northeast on SH-33 for 1.13 miles & turn right on SH-54. Head south for 1.80 miles & turn left on E-0890 Rd. Head east for 4.50 miles & turn right on N-2445 Rd. & head south for 0.50 miles & turn left on E-0895 Rd. Head east for 0.50 miles to the existing

access road.

THE INFORMATION SHOWN HEREIN IS FOR CONSTRUCTION PURPOSES ONLY

LANDING POINT, BOTTOM HOLE AND DRILL PATH INFORMATION PROVIDED BY OPERATOR LISTED, NOT SURVEYED.

Well SH-2: B PERKINS 2-6-7-18XHM

Certificate of Authorization No. 7318




Prepared By: PSLS 14612 Bogert Parkway Oklahoma City, OK 73134 EXHIBIT: _____C


SHEET: 8.5×11

SHL: $\frac{6-14N-13W}{18-14N-13W}$



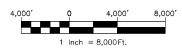

VICINITY MAP

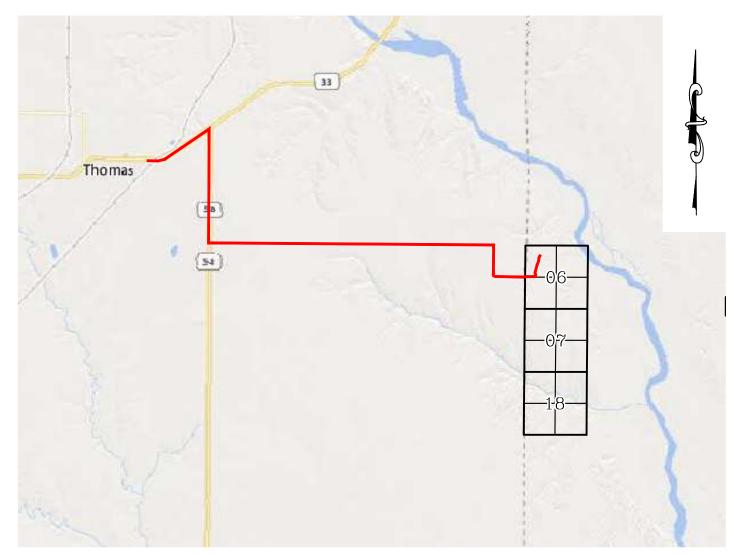

LEAVING THOMAS, HEAD NORTHEAST ON SH-33 FOR 1.13 MILES & TURN RIGHT ON SH-54. HEAD SOUTH FOR 1.80 MILES & TURN LEFT ON E-0890 RD. HEAD EAST FOR 4.50 MILES & TURN RIGHT ON N-2445 RD. & HEAD SOUTH FOR 0.50 MILES & TURN LEFT ON E-0895 RD. HEAD EAST FOR 0.50 MILES TO THE EXISTING ACCESS ROAD.

CONTINENTAL RESOURCES, INC.

P.O. BOX 26900 OKLAHOMA CITY, OK 73126 * (T) 1-800-256-8955 (F) 405-234-9253



Prepared By: Petro Land Services South 14612 Bogert Parkway Oklahoma City, OK 73134

Section	6 Township	14NRange	13W I.M .	Well SH-2:B	PERKINS	2-6-7-18XHM
County	BLAINE	State	OK			

Operator _____CONTINENTAL RESOURCES, INC.

EXHIBIT: _____

SHEET: <u>8.5x11</u>

SHL:

6 - 14N - 13W

BHL-2: <u>18-14N-13W</u>



Well SH-2: B PERKINS 2-6-7-18XHM

FACING NORTH

(NO IMAGES AVAILABLE)

FACING SOUTH

(NO IMAGES AVAILABLE)

CURRENT REV.: 0

Prepared By:



TERRAIN

DRAWN BY:	HDG	SCALE:	N.T.S.
CHECKED BY:	MJL	JOB No.:	
APPROVED BY:		DWG. NO.:	TERRAIN-1
DATE ISSUED:	01-13-22	SHEET:	1 OF 2

EXHIBIT: ____E

SHEET: <u>8.5x11</u>

6 - 14N - 13W

SHL: BHL-2: <u>18-14N-13W</u>



Well SH-2: B PERKINS 2-6-7-18XHM

FACING EAST

(NO IMAGES AVAILABLE)

FACING WEST

(NO IMAGES AVAILABLE)

CURRENT REV.: 0

Prepared By:



TERRAIN


DRAWN BY:	HDG	SCALE:	N.T.S.
CHECKED BY:	MJL	JOB No.:	
APPROVED BY:		DWG. NO.:	TERRAIN-2
DATE ISSUED:	01-13-22	SHEET:	2 OF 2

EXHIBIT: ____F

SHEET: $\frac{8.5 \times 11}{6 - 14 N - 13 W}$ BHL-2: $\frac{18 - 14 N - 13 W}{18 - 14 N - 13 W}$



PROPOSED ACCESS ROAD = 487' | 29.52 RODS (TOTAL)

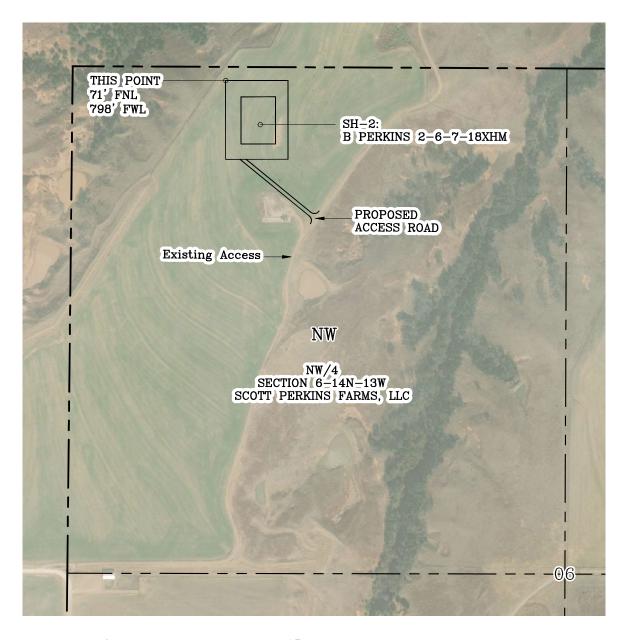

Section $\frac{6}{}$ Township $\frac{14N}{}$ Range $\frac{13W}{}$ I.M.

County _____BLAINE ___State ___OK

Operator _____CONTINENTAL RESOURCES, INC.




CURRENT REV.: 0

Prepared



AERIAL PLAT

DRAWN BY:	HDG	SCALE:	1" = 500'
CHECKED BY:	MJL	JOB No.:	
APPROVED BY:		DWG. NO.:	AERIAL-1
DATE ISSUED:	01-13-22	SHEET:	1 OF 4

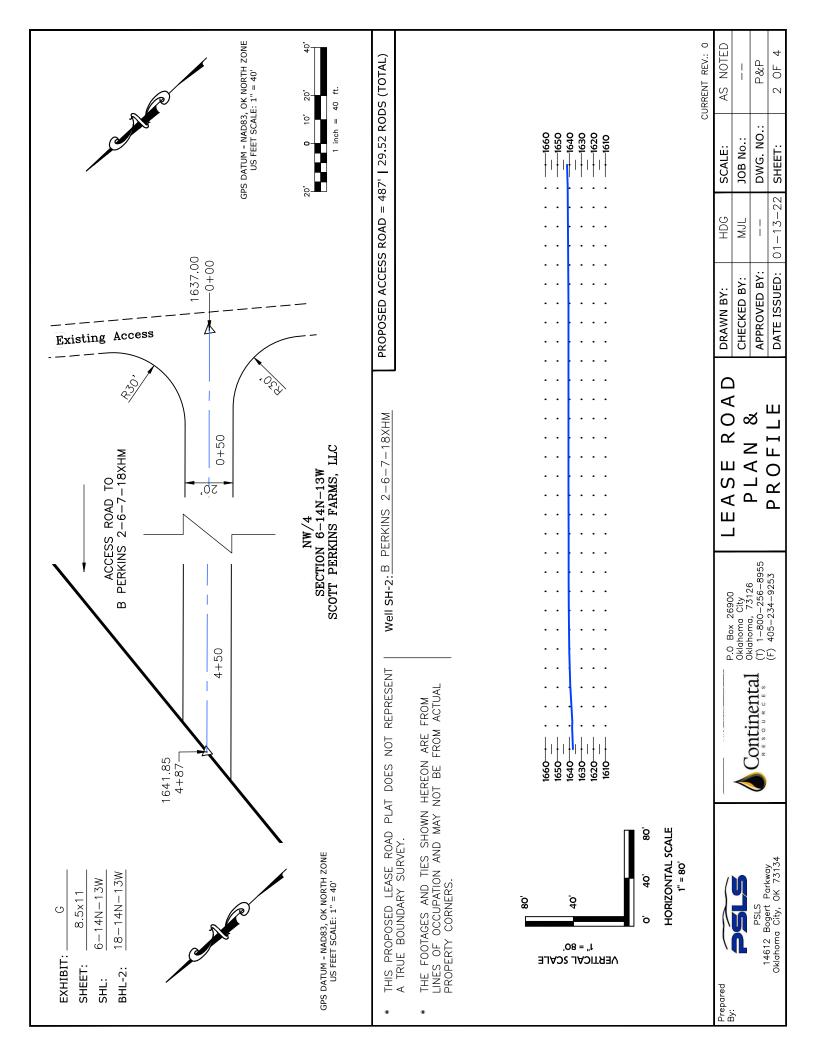


Well SH-2: B PERKINS 2-6-7-18XHM

EXHIBIT: H

SHEET: $\frac{8.5 \times 11}{6 - 14 \text{N} - 13 \text{W}}$

BHL-2: 18-14N-13W



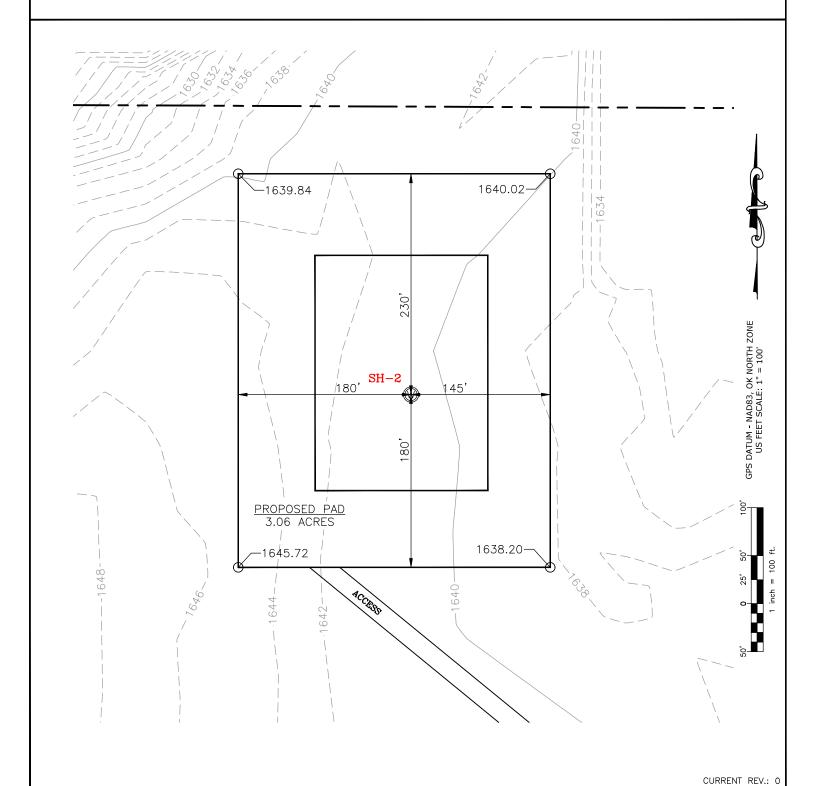

Prepared By:



EXISTING GRADING PLAN


DRAWN BY:	HDG	SCALE:	1" = 100'
CHECKED BY:	MJL	JOB No.:	
APPROVED BY:		DWG. NO.:	EX-GR.
DATE ISSUED:	01-13-22	SHEET:	3 OF 4

EXHIBIT: ______ | SHEET: _____ 8.5x11

SHL: $\frac{6-14N-13W}{18-14N-13W}$





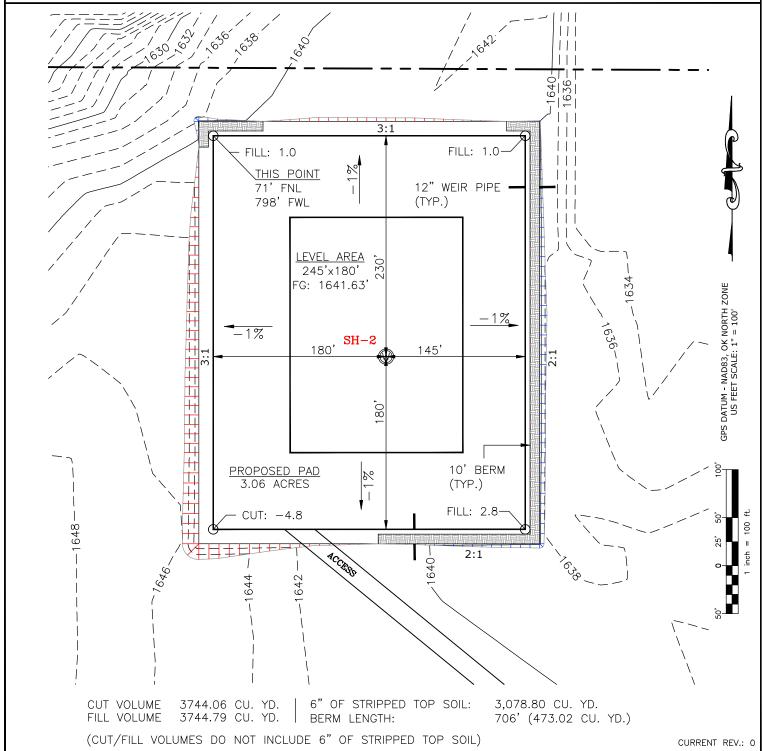

Prepared



PROPOSED GRADING PLAN

DRAWN BY:	HDG	SCALE:	1" = 100'
CHECKED BY:	MJL	JOB No.:	
APPROVED BY:		DWG. NO.:	PRO-GR.
DATE ISSUED:	01-13-22	SHEET:	4 OF 4

EXHIBIT "A"


TABLE OF QUANTITIES

DISTURBED AREA = 3.82 ACRES ACCESS ROAD = ±487'

LOCATED ON THE LANDS OF: SCOTT PERKINS FARMS, LLC

NW/4 SEC 6-14N-13W BLAINE COUNTY, OKLAHOMA



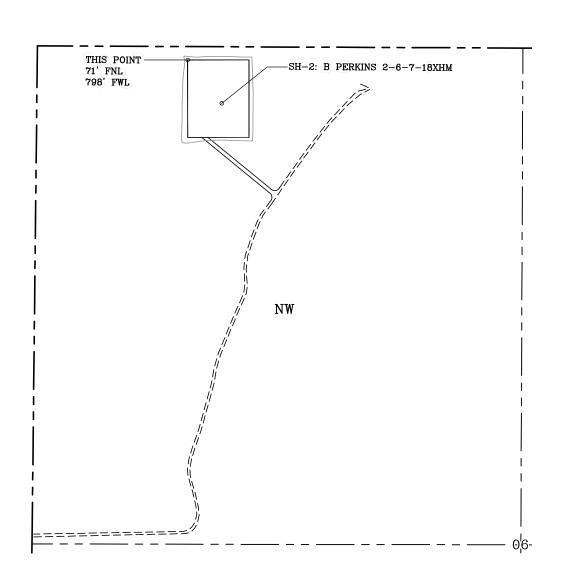

GENERAL NOTES:

- 1. THIS IS NOT A BOUNDARY SURVEY.
- 2. THIS SURVEY DOES NOT GUARANTEE TITLE OR OWNERSHIP.

