

API NUMBER: 049 25369

OKLAHOMA CORPORATION COMMISSION  
OIL & GAS CONSERVATION DIVISION  
P.O. BOX 52000  
OKLAHOMA CITY, OK 73152-2000  
(Rule 165:10-3-1)

Approval Date: 06/15/2022  
Expiration Date: 12/15/2023

Multi Unit Oil & Gas

**PERMIT TO DRILL**

WELL LOCATION: Section: 19 Township: 1N Range: 1W County: GARVIN

SPOT LOCATION:     FEET FROM QUARTER: FROM NORTH FROM WEST  
SECTION LINES: 980 1575

Lease Name: SPEYSIDE Well No: 6-19-20XHM Well will be 980 feet from nearest unit or lease boundary.

Operator Name: CONTINENTAL RESOURCES INC Telephone: 4052349000; 4052349000; OTC/OCC Number: 3186 0

CONTINENTAL RESOURCES INC

OKLAHOMA CITY, OK 73126

ALLAN B. HENSLEY ET AL

31335 N COUNTY ROAD 3170

ELMORE CITY OK 73433-9070

Formation(s) (Permit Valid for Listed Formations Only):

	Name	Code	Depth
1	SYCAMORE	352SCMR	12400
2	WOODFORD	319WDFD	12480

Spacing Orders: 169883  
172043

Location Exception Orders: No Exceptions

Increased Density Orders: No Density

Pending CD Numbers: 202201695  
202201696  
202201697  
202201698

Working interest owners' notified: \*\*\*

Special Orders: No Special

Total Depth: 21400 Ground Elevation: 871

Surface Casing: 1500

Depth to base of Treatable Water-Bearing FM: 110

Deep surface casing has been approved

Under Federal Jurisdiction: No  
Fresh Water Supply Well Drilled: No  
Surface Water used to Drill: Yes

Approved Method for disposal of Drilling Fluids:

D. One time land application -- (REQUIRES PERMIT)

PERMIT NO: 22-38335

H. (Other)

SEE MEMO

**PIT 1 INFORMATION**

Type of Pit System: CLOSED Closed System Means Steel Pits

Type of Mud System: WATER BASED

Chlorides Max: 5000 Average: 3000

Is depth to top of ground water greater than 10ft below base of pit? Y

Within 1 mile of municipal water well? N

Wellhead Protection Area? N

Pit is located in a Hydrologically Sensitive Area.

Category of Pit: C

Liner not required for Category: C

Pit Location is: ALLUVIAL

Pit Location Formation: ALLUVIUM

**PIT 2 INFORMATION**

Type of Pit System: CLOSED Closed System Means Steel Pits

Type of Mud System: OIL BASED

Chlorides Max: 300000 Average: 200000

Is depth to top of ground water greater than 10ft below base of pit? Y

Within 1 mile of municipal water well? N

Wellhead Protection Area? N

Pit is located in a Hydrologically Sensitive Area.

Category of Pit: C

Liner not required for Category: C

Pit Location is: ALLUVIAL

Pit Location Formation: ALLUVIUM

This permit does not address the right of entry or settlement of surface damages. The duration of this permit is 18 MONTHS, except as otherwise provided by Rule 165: 10-3-1. Rule 165: 10-3-4 (c) (7) (e) - The Operator shall give 24 Hours notice by telephone to the appropriate District Office of the Conservation Division as to when Surface Casing will be run.

## MULTI UNIT HOLE 1

Section: 20	Township: 1N	Range: 1W	Meridian: IM	Total Length: 9000
County: GARVIN				Measured Total Depth: 21400
Spot Location of End Point: E2	NE	NE	NE	True Vertical Depth: 14034
Feet From: <b>NORTH</b>	1/4 Section Line: 330		End Point Location from	
Feet From: <b>EAST</b>	1/4 Section Line: 50		Lease, Unit, or Property Line: 50	

## NOTES:

Category	Description
DEEP SURFACE CASING	[6/2/2022 - GB6] - APPROVED; NOTIFY OCC FIELD INSPECTOR IMMEDIATELY OF ANY LOSS OF CIRCULATION OR FAILURE TO CIRCULATE CEMENT TO SURFACE ON ANY CONDUCTOR OR SURFACE CASING
HYDRAULIC FRACTURING	[6/2/2022 - GB6] - OCC 165:10-3-10 REQUIRES: 1) NOTICE SHALL BE GIVEN AT LEAST 5 BUSINESS DAYS PRIOR TO COMMENCEMENT OF HYDRAULIC FRACTURING OPERATIONS ON A HORIZONTAL WELL TO OPERATORS PRODUCING WELLS WITHIN 1 MILE OF THE COMPLETION INTERVAL OF THE SUBJECT WELL. THE NOTICE TO SUCH OPERATORS SHALL CONTAIN THE INFORMATION IN FORM 6000NOO. IF THE HYDRAULIC FRACTURING OPERATIONS SCHEDULE CHANGES AFTER NOTICE HAS BEEN PROVIDED, RESULTING IN A DELAY OF OPERATIONS OF MORE THAN 5 DAYS FROM THE INITIAL NOTICE, NEW NOTICE IS REQUIRED TO BE GIVEN; 2) NOTICE WILL BE GIVEN TO THE OCC CENTRAL OFFICE AND LOCAL DISTRICT OFFICES AT LEAST 48 HOURS PRIOR TO COMMENCEMENT OF HYDRAULIC FRACTURING OPERATIONS. FORM 6000NHF SHALL BE USED AND IS FOUND AT THIS LINK: <a href="http://OCCEWEB.COM/OG/OGFORMS.HTML">OCCEWEB.COM/OG/OGFORMS.HTML</a> ; AND, 3) THE CHEMICAL DISCLOSURE OF HYDRAULIC FRACTURING INGREDIENTS FOR ALL WELLS IS TO BE REPORTED TO FRACFOCUS WITHIN 60 DAYS AFTER THE CONCLUSION OF HYDRAULIC FRACTURING OPERATIONS, FOUND AT <a href="http://FRACFOCUS.ORG">FRACFOCUS.ORG</a>
MEMO	[6/2/2022 - GB6] - CLOSED SYSTEM=STEEL PITS (REQUIRED - WILDHORSE CREEK AND ROCK CREEK), OBM RETURNED TO VENDOR, CUTTINGS PERMITTED PER DISTRICT
PENDING CD – 2022-001697	[6/2/2022 - GB6] - (I.O.) 19-1N-1W X169883/172043 WDFD, SCMR 3 WELLS WDFD 1 WELL SCMR NO OPER. NAMED REC. 06/06/2022 (MOORE)
PENDING CD – 2022-001698	[6/2/2022 - GB6] - (I.O.) 20-1N-1W X169883/172043 WDFD, SCMR 3 WELLS WDFD 2 WELL SCMR NO OPER. NAMED REC. 06/06/2022 (MOORE)
PENDING CD – CD2022-001695	[6/2/2022 - GB6] - (I.O.) 19 & 20 -1N-1W EST MULTIUNIT HORIZONTAL WELL X169883/172043 SCMR, WDFD 19, 20 -1N-1W (WDFD ADJACENT COMMON SOURCES OF SUPPLY TO SCMR) 43% 19-1N-1W 57% 20-1N-1W NO OPER. NAMED REC. 06/06/2022 (MOORE)
PENDING CD – CD2022-001696	[6/2/2022 - GB6] - (I.O.) 19 & 20 -1N-1W X169883/172043 SCMR, WDFD 19, 20 -1N-1W COMPL. INT. (19-1N-1W) NCT 330' FWL, NCT 0' FEL, NCT 330' FNL COMPL. INT. (20-1N-1W) NCT 0' FWL, NCT 165' FEL, NCT 330' FNL NO OPER. NAMED REC. 06/06/2022 (MOORE)
SPACING – 169883	[6/2/2022 - GB6] - (640) 19, 20 -1N-1W EXT 161935 SCMR, WDFD, OTHERS
SPACING – 172043	[6/2/2022 - GB6] - X169883 CORRECT AND CONFIRM THAT SPACING IS 640-ACRE DRILL SPACE UNITS

EXHIBIT: A (1 of 3)  
SHEET: 8.5x14  
SHL: 19-1N-1W  
BHL-5: 20-1N-1W  
BHL-6: 20-1N-1W



WELL PAD ID:  
4A99E303-1774-2268-B437-CAB2CE60EBEA  
  
SH-5-ID: SB8LBIUDA3  
SH-6-ID: SBDFG026Q0

COVER SHEET

CONTINENTAL RESOURCES, INC.  
P.O. BOX 26900 OKLAHOMA CITY, OK 73126 \* (T) 1-800-256-8955 (F) 405-234-9253

Section 19 Township 1N Range 1W I.M. SH-5: SPEYSIDE 5-19-20XHW  
County GARVIN State OK SH-6: SPEYSIDE 6-19-20XHM  
Operator CONTINENTAL RESOURCES, INC.

NAD-83							EXISTING ELEVATION	DESIGN ELEVATION
POINT	WELL NAME	NORTHING	EASTING	LATITUDE LONGITUDE	LATITUDE LONGITUDE			
SH-5	SPEYSIDE 5-19-20XHW	442552	2165036	34° 32' 51.56" -97° 20' 50.33"	34.547655 -97.347313	1010' FNL / 1575' FWL (SW/4 SW/4 NE/4 NW/4 SEC 19)	870.58'	873.47'
LP-5	LANDING POINT	442462	2165037	34° 32' 50.67" -97° 20' 50.32"	34.547407 -97.347312	1100' FNL / 1575' FWL (NW/4 SEC 19)	--	--
BHL-5	BOTTOM HOLE LOCATION	442519	2173961	34° 32' 50.65" -97° 19' 03.63"	34.547403 -97.317675	1100' FNL / 50' FEL (NE/4 SEC 20)	--	--
SH-6	SPEYSIDE 6-19-20XHM	442582	2165036	34° 32' 51.85" -97° 20' 50.32"	34.547737 -97.347312	980' FNL / 1575' FWL (NW/4 SW/4 NE/4 NW/4 SEC 19)	870.55'	873.47'
LP-6	LANDING POINT	443232	2165032	34° 32' 58.28" -97° 20' 50.32"	34.549523 -97.347311	330' FNL / 1575' FWL (NW/4 SEC 19)	--	--
BHL-6	BOTTOM HOLE LOCATION	443289	2173954	34° 32' 58.27" -97° 19' 03.65"	34.549519 -97.317682	330' FNL / 50' FEL (NE/4 SEC 20)	--	--
X-1	B & W FREEMAN HEIRS #1-20	442943	2173340	34° 32' 54.88" -97° 19' 11.02"	34.548577 -97.319728	20-1N-1W:   TD: 13,500'   673' FNL / 667' FEL	--	--
X-2	A C HOLBROOK #1	439301	2169747	34° 32' 19.09" -97° 19' 54.26"	34.538636 -97.331740	20-1N-1W:   TD: UNKNOWN'   990' FSL / 990' FWL	--	--
X-3	HENNEPIN UNIT #1	439960	2169738	34° 32' 25.62" -97° 19' 54.32"	34.540449 -97.331755	20-1N-1W:   TD: 15,917'   1650' FSL / 990' FWL	--	--
X-4	WILEY BROTHERS #1-20	442738	2173202	34° 32' 52.86" -97° 19' 12.69"	34.548018 -97.320192	20-1N-1W:   TD: 13,965'   876' FNL / 807' FEL	--	--
X-5	OBELE-KATIE #7	442893	2164119	34° 32' 54.99" -97° 21' 01.26"	34.548608 -97.350351	19-1N-1W:   TD: 4,272'   663' FNL / 660' FWL	--	--
X-6	WARREN #1-30-29XH	438544	2164061	34° 32' 11.98" -97° 21' 02.30"	34.536660 -97.350638	19-1N-1W:   TD: 17,502'   275' FSL / 575' FWL	--	--
X-7	JAMES TRUST #1-24-23XHW	443254	2163757	34° 32' 58.58" -97° 21' 05.56"	34.549607 -97.351546	19-1N-1W:   TD: 22,952'   300' FNL / 300' FWL	--	--
X-8	SPEYSIDE #1-20-19XHW	441038	2173726	34° 32' 36.01" -97° 19' 06.57"	34.543336 -97.318491	20-1N-1W:   TD: 21,620'   2580' FNL / 300' FEL	--	--

NAD-27							EXISTING ELEVATION	DESIGN ELEVATION
POINT	WELL NAME	NORTHING	EASTING	LATITUDE LONGITUDE	LATITUDE LONGITUDE			
SH-5	SPEYSIDE 5-19-20XHW	442509	2196632	34° 32' 51.25" -97° 20' 49.24"	34.547571 -97.347012	1010' FNL / 1575' FWL (SW/4 SW/4 NE/4 NW/4 SEC 19)	870.58'	873.47'
LP-5	LANDING POINT	442419	2196632	34° 32' 50.36" -97° 20' 49.24"	34.547323 -97.347011	1100' FNL / 1575' FWL (NW/4 SEC 19)	--	--
BHL-5	BOTTOM HOLE LOCATION	442477	2205557	34° 32' 50.35" -97° 19' 02.55"	34.547319 -97.317374	1100' FNL / 50' FEL (NE/4 SEC 20)	--	--
SH-6	SPEYSIDE 6-19-20XHM	442539	2196632	34° 32' 51.55" -97° 20' 49.24"	34.547653 -97.347011	980' FNL / 1575' FWL (NW/4 SW/4 NE/4 NW/4 SEC 19)	870.55'	873.47'
LP-6	LANDING POINT	443189	2196628	34° 32' 57.98" -97° 20' 49.24"	34.549439 -97.347010	330' FNL / 1575' FWL (NW/4 SEC 19)	--	--
BHL-6	BOTTOM HOLE LOCATION	443246	2205550	34° 32' 57.96" -97° 19' 02.57"	34.549435 -97.317381	330' FNL / 50' FEL (NE/4 SEC 20)	--	--
X-1	B & W FREEMAN HEIRS #1-20	442900	2204936	34° 32' 54.58" -97° 19' 09.94"	34.548493 -97.319428	20-1N-1W:   TD: 13,500'   673' FNL / 667' FEL	--	--
X-2	A C HOLBROOK #1	439258	2201343	34° 32' 18.79" -97° 19' 53.18"	34.538552 -97.331439	20-1N-1W:   TD: UNKNOWN'   990' FSL / 990' FWL	--	--
X-3	HENNEPIN UNIT #1	439918	2201334	34° 32' 25.31" -97° 19' 53.23"	34.540365 -97.331454	20-1N-1W:   TD: 15,917'   1650' FSL / 990' FWL	--	--
X-4	WILEY BROTHERS #1-20	442695	2204797	34° 32' 52.56" -97° 19' 11.61"	34.547933 -97.319891	20-1N-1W:   TD: 13,965'   876' FNL / 807' FEL	--	--
X-5	OBELE-KATIE #7	442850	2195715	34° 32' 54.69" -97° 21' 00.18"	34.548524 -97.350049	19-1N-1W:   TD: 4,272'   663' FNL / 660' FWL	--	--
X-6	WARREN #1-30-29XH	438502	2195656	34° 32' 11.67" -97° 21' 01.21"	34.536576 -97.350337	19-1N-1W:   TD: 17,502'   275' FSL / 575' FWL	--	--
X-7	JAMES TRUST #1-24-23XHW	443211	2195353	34° 32' 58.28" -97° 21' 04.48"	34.549523 -97.351244	19-1N-1W:   TD: 22,952'   300' FNL / 300' FWL	--	--
X-8	SPEYSIDE #1-20-19XHW	440995	2205321	34° 32' 35.71" -97° 19' 05.49"	34.543252 -97.318190	20-1N-1W:   TD: 21,620'   2580' FNL / 300' FEL	--	--

Certificate of Authorization No. 7318



Prepared By:  
PSLS  
14612 Bogert Parkway  
Oklahoma City, OK 73134

R E V I S I O N S					
No.	DATE	STAKED	BY	DESCRIPTION	COMMENTS
00	05-13-22	**--**-22	HDG	ISSUED FOR APPROVAL	--

EXHIBIT: A (2 of 3)  
SHEET: 8.5x14  
SHL: 19-1N-1W  
BHL-5: 20-1N-1W


PETRO LAND SERVICES SOUTH, LLC  
14612 BOGERT PARKWAY, OKLA. CITY, OKLA. 73134 \* OFFICE (405) 212-3108  
Certificate of Authorization No. 7318



CONTINENTAL  
RESOURCES, INC  
(OPERATOR)

GARVIN County Oklahoma  
1010' FNL-1575' FWL Section 19 Township 1N Range 1W I.M.

WELL: SPEYSIDE  
5-19-20XHW

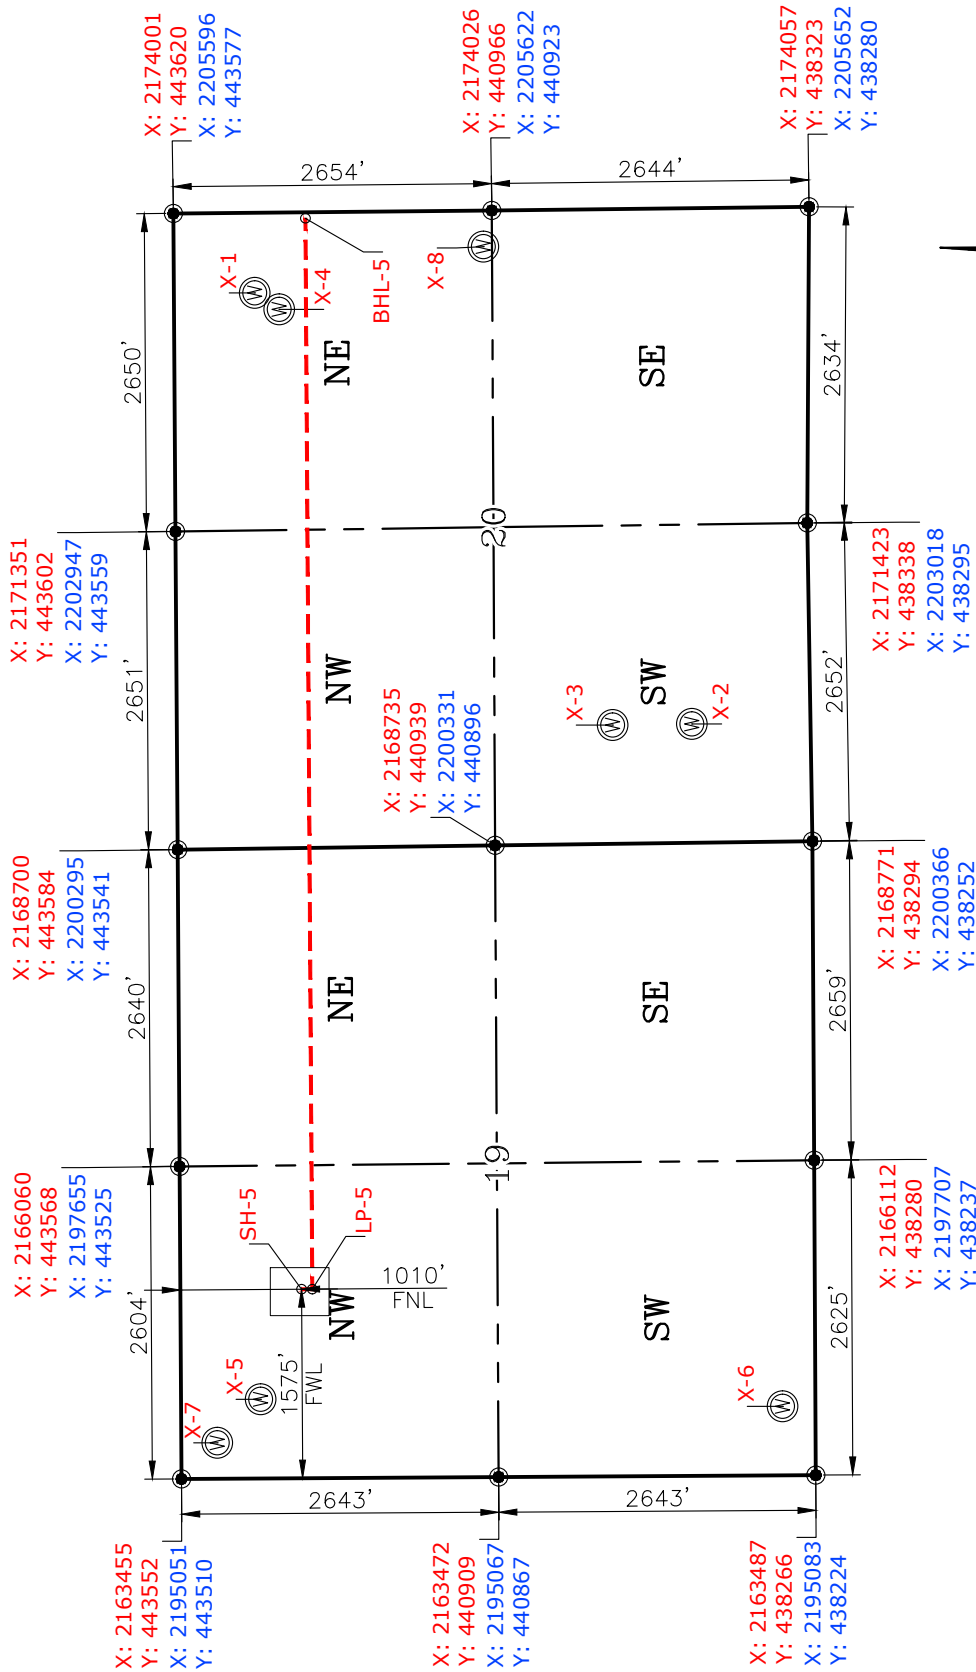

GPS DATUM  
NAD-83  
NAD-27  
OK SOUTH ZONE  
US FEET  
SCALE:  
1" = 1600'

CURRENT REV.: 0

Date Drawn: 05-13-22

Please note that this location was staked on the ground under the supervision of a Licensed Professional Land Surveyor, but the accuracy of this survey is not guaranteed. Please contact PLS promptly if any inconsistency is determined. GPS data is observed from RTK-GPS. NOTE: X and Y data shown hereon for Section Corners may NOT have been surveyed on-the-ground, and further, does NOT represent a true Boundary Survey. Quarter Section distances may be assumed from a Government Survey Plat or assumed at a proportionate distance from opposing section corners, or occupation thereof, and may not have been measured on-the-ground, and further, does not represent a true Boundary Survey.

CERTIFICATE:

I, FRED A. SELENSKY, an Oklahoma Licensed Land Surveyor and an authorized agent of Petro Land Services South, LLC, do hereby certify to the information shown herein.



*Fred A. Selensky*  
Oklahoma PLS No.1860 DATE 5-13-22

EXHIBIT: A (3 of 3)  
SHEET: 8.5x14  
SHL: 19-1N-1W  
BHL-6: 20-1N-1W



PETRO LAND SERVICES SOUTH, LLC  
14612 BOGERT PARKWAY, OKLA. CITY, OKLA. 73134 \* OFFICE (405) 212-3108  
Certificate of Authorization No. 7318



CONTINENTAL  
RESOURCES, INC  
(OPERATOR)

GARVIN County Oklahoma  
980' FNL-1575' FWL Section 19 Township 1N Range 1W I.M.

WELL: SPEYSIDE  
6-19-20XHM

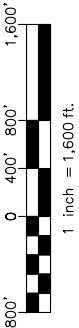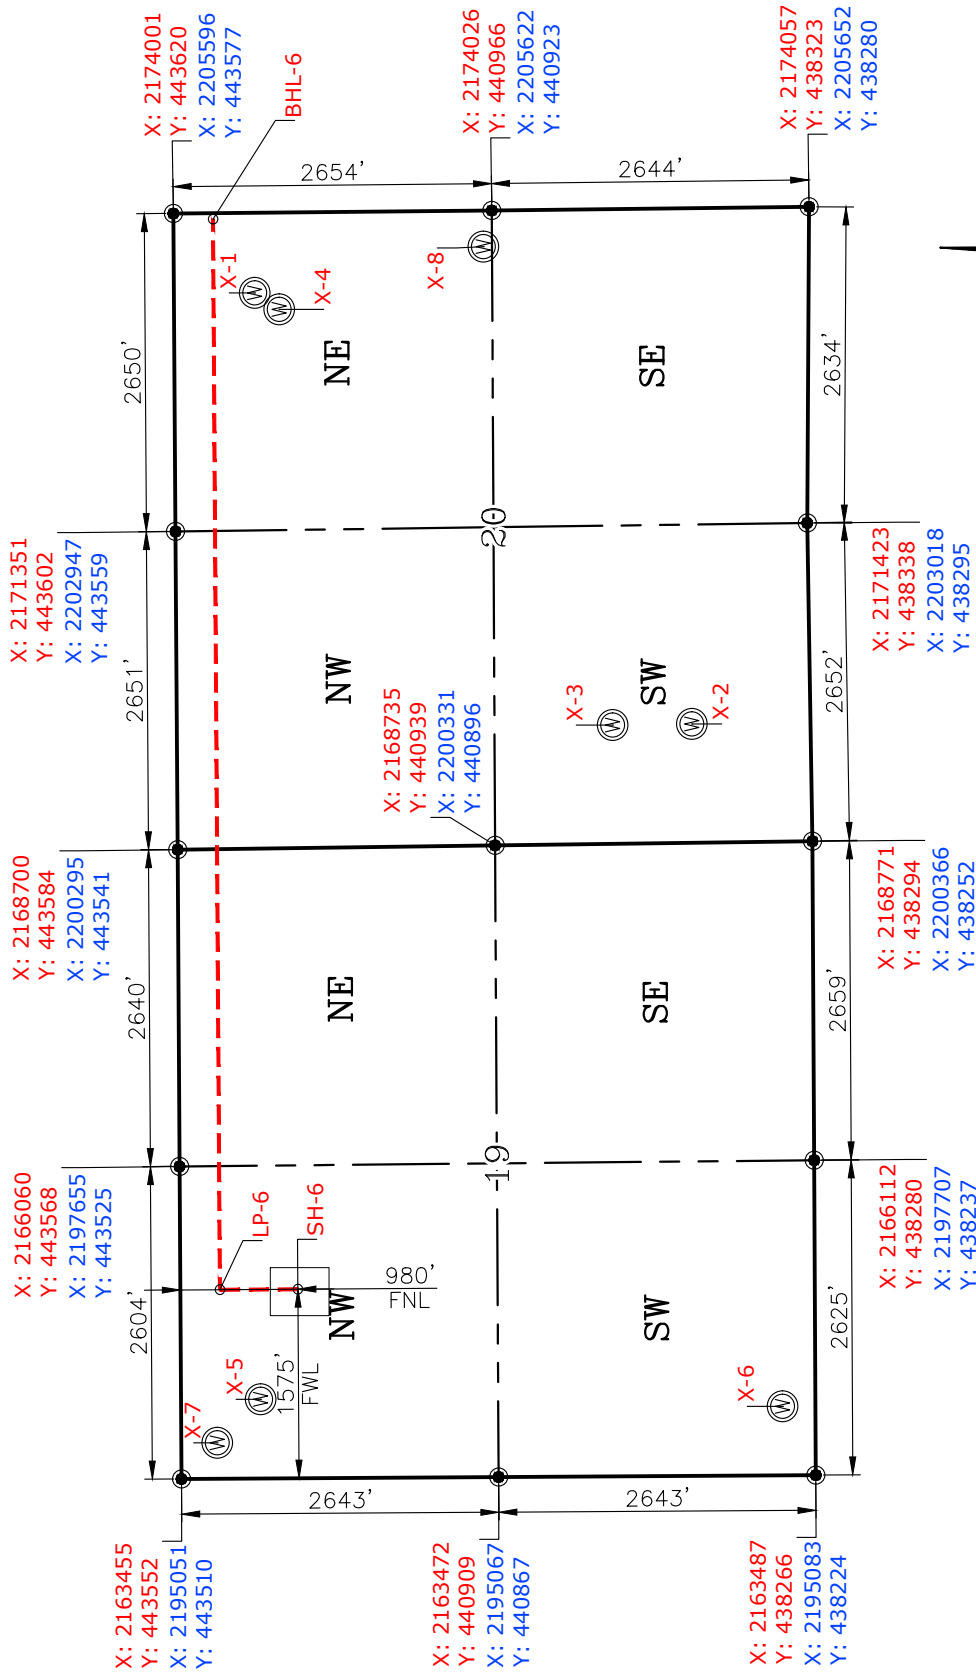

GPS DATUM  
NAD-83  
NAD-27  
OK SOUTH ZONE  
US FEET  
SCALE:  
1" = 1600'

CURRENT REV.: 0

Date Drawn: 05-13-22

Please note that this location was staked on the ground under the supervision of a Licensed Professional Land Surveyor, but the accuracy of this survey is not guaranteed. Please contact PLS promptly if any inconsistency is determined. GPS data is observed from RTK-GPS. NOTE: X and Y data shown hereon for Section Corners may NOT have been surveyed on-the-ground, and further, does NOT represent a true Boundary Survey. Quarter Section distances may be assumed from a Government Survey Plat or assumed at a proportionate distance from opposing section corners, or occupation thereof, and may not have been measured on-the-ground, and further, does not represent a true Boundary Survey.

CERTIFICATE:

I, FRED A. SELENSKY, an Oklahoma Licensed Land Surveyor and an authorized agent of Petro Land Services South, LLC, do hereby certify to the information shown herein.



*Fred A. Selensky*  
Oklahoma PLS No.1860 DATE 5-13-22

EXHIBIT: B  
SHEET: 8.5x11  
SHL: 19-1N-1W  
BHL-5: 20-1N-1W  
BHL-6: 20-1N-1W


# PETRO LAND SERVICES SOUTH, LLC

14612 BOGERT PARKWAY, OKLA. CITY, OKLA. 73134 \* OFFICE (405) 212-3108  
Certificate of Authorization No. 7318



CONTINENTAL  
RESOURCES, INC  
(OPERATOR)

SH-5: 1010' FNL-1575' FWL GARVIN County Oklahoma  
SH-6: 980' FNL-1575' FWL Section 19 Township 1N Range 1W I.M.

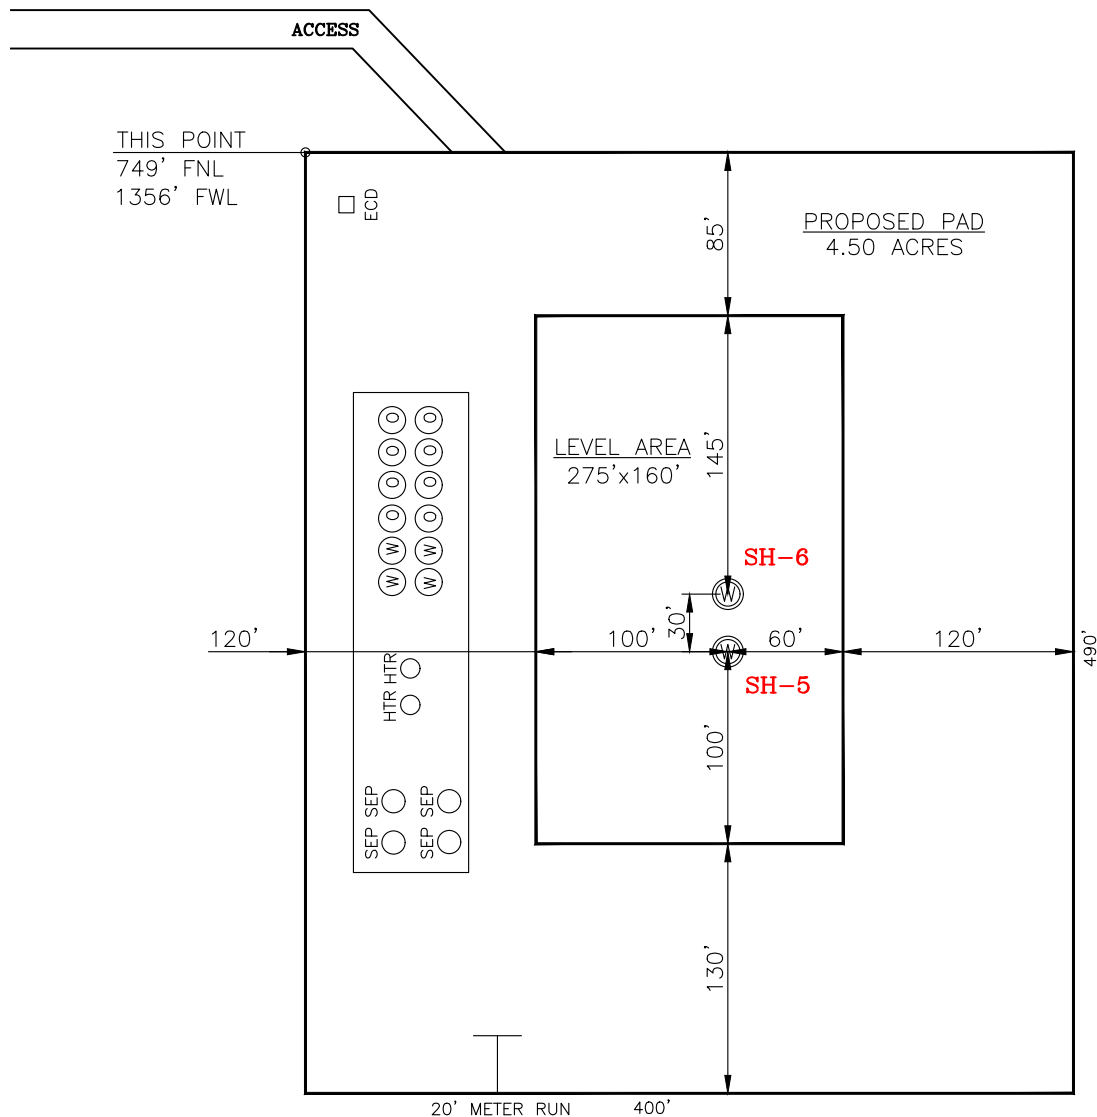

CURRENT REV.: 0

SH-5: SPEYSIDE 5-19-20XHW

DATUM: NAD-83

NORTHING: 442552

EASTING: 2165036

LAT: N34°32'51.56"

LONG: W97°20'50.33"

LAT: 34.547655°

LONG: -97.347313°

STATE PLANE  
COORDINATES  
(US FEET): SOUTH

SH-6: SPEYSIDE 6-19-20XHM

DATUM: NAD-83

NORTHING: 442582

EASTING: 2165036

LAT: N34°32'51.85"

LONG: W97°20'50.32"

LAT: 34.547737°

LONG: -97.347312°

Operator: CONTINENTAL RESOURCES, INC.

Lease Name: --

Topography & Vegetation: Pasture Good Drill Site? Yes

Reference Stakes or Alternate Location Stakes Set: No

Best Accessibility to Location: From The West Line

Distance & Direction From Hwy. or Town: Leaving Hennepin, head north on Katie Rd. for 2.76 miles to the existing access road.

THE INFORMATION SHOWN  
HEREIN IS FOR CONSTRUCTION  
PURPOSES ONLY

Well SH-5: SPEYSIDE 5-19-20XHW

Well SH-6: SPEYSIDE 6-19-20XHM

Certificate of Authorization No. 7318




Prepared By:  
PSLS  
14612 Bogert Parkway  
Oklahoma City, OK 73134


LANDING POINT, BOTTOM HOLE AND DRILL PATH  
INFORMATION PROVIDED BY OPERATOR LISTED,  
NOT SURVEYED.

( This Information Was Gathered With a GPS  
Receiver With ±1 Foot Horiz./Vert. Accuracy  
Certificate of Authorization No. 7318 )

EXHIBIT: C  
SHEET: 8.5x11  
SHL: 19-1N-1W  
BHL-5: 20-1N-1W  
BHL-6: 20-1N-1W

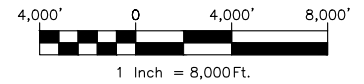

## VICINITY MAP

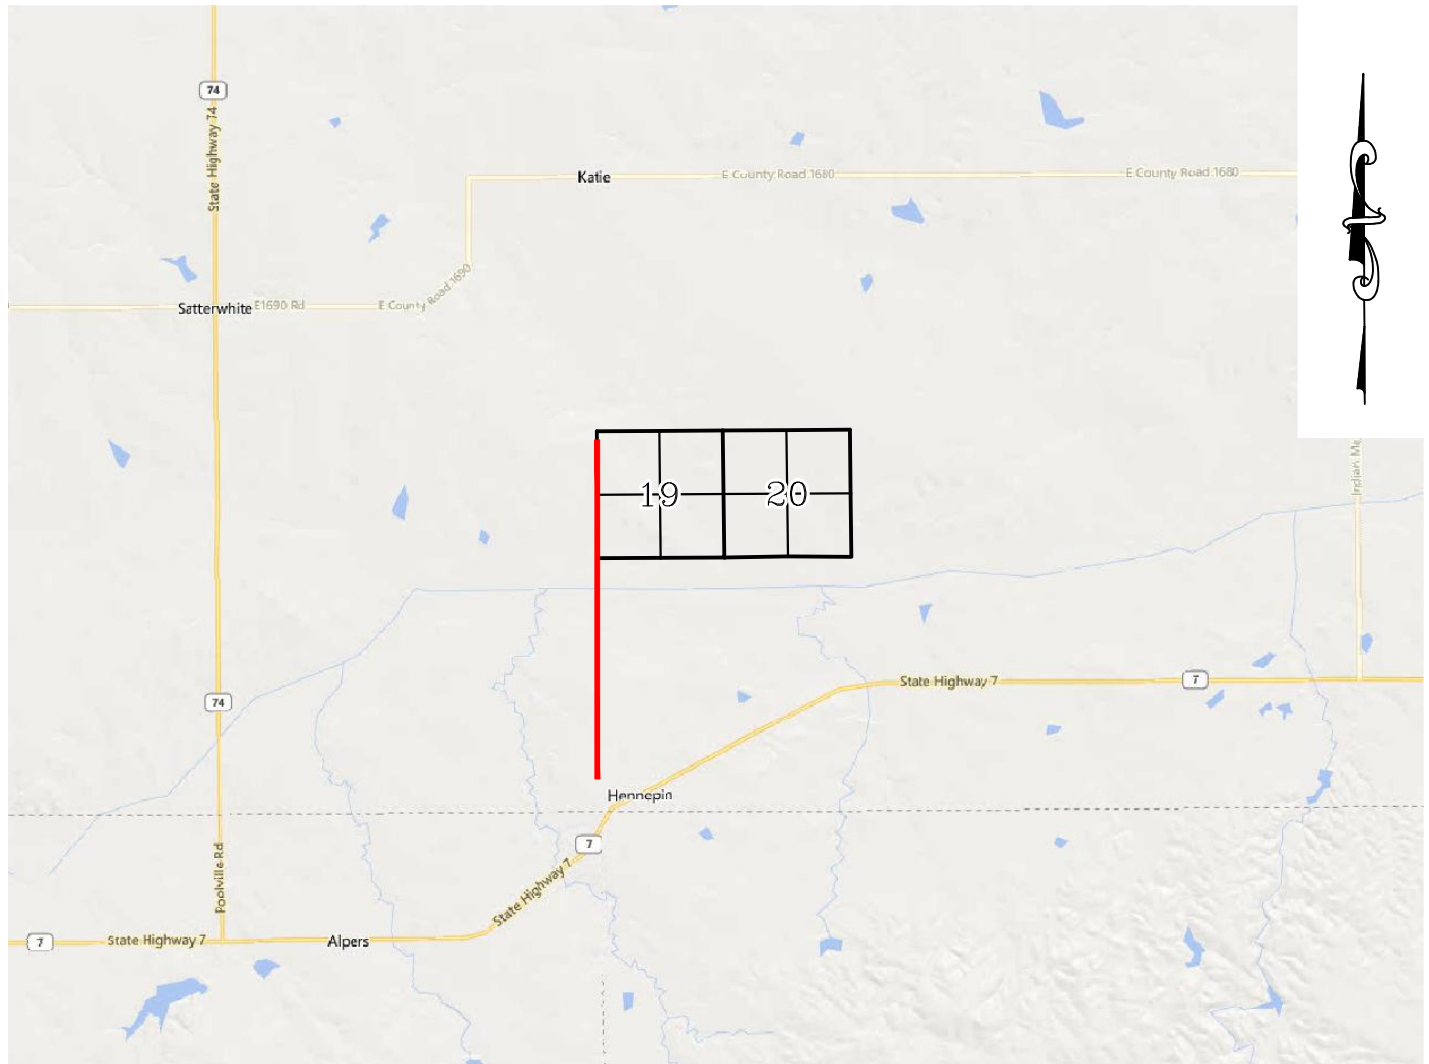

LEAVING HENNEPIN, HEAD NORTH ON KATIE RD. FOR 2.76 MILES TO THE EXISTING ACCESS ROAD.

### CONTINENTAL RESOURCES, INC.

P.O. BOX 26900 OKLAHOMA CITY, OK 73126 \* (T) 1-800-256-8955 (F) 405-234-9253



Prepared By:  
Petro Land Services South  
14612 Bogert Parkway  
Oklahoma City, OK 73134

Section 19 Township 1N Range 1W I.M. Well SH-5: SPEYSIDE 5-19-20XHW  
County GARVIN State OK Well SH-6: SPEYSIDE 6-19-20XHM  
Operator CONTINENTAL RESOURCES, INC.

EXHIBIT:       D        
SHEET:       8.5x11        
SHL:       19-1N-1W        
BHL-5:       20-1N-1W        
BHL-6:       20-1N-1W      



Well SH-5:       SPEYSIDE 5-19-20XHW        
Well SH-6:       SPEYSIDE 6-19-20XHM      

FACING NORTH

(NO IMAGES AVAILABLE)

FACING SOUTH

(NO IMAGES AVAILABLE)

CURRENT REV.: 0

Prepared By:	PSLS 14612 Bogert Parkway. Oklahoma City, OK 73134	TERRAIN				DRAWN BY:	HDG	SCALE:	N.T.S.
						CHECKED BY:	MJL	JOB No.:	--
						APPROVED BY:	--	DWG. NO.:	TERRAIN-1
						DATE ISSUED:	05-13-22	SHEET:	1 OF 2

EXHIBIT: E  
SHEET: 8.5x11  
SHL: 19-1N-1W  
BHL-5: 20-1N-1W  
BHL-6: 20-1N-1W



Well SH-5: SPEYSIDE 5-19-20XHW  
Well SH-6: SPEYSIDE 6-19-20XHM

FACING EAST

(NO IMAGES AVAILABLE)

FACING WEST

(NO IMAGES AVAILABLE)

CURRENT REV.: 0


Prepared By:  PSLS 14612 Bogert Parkway, Oklahoma City, OK 73134	TERRAIN	DRAWN BY:	HDG	SCALE:	N.T.S.
		CHECKED BY:	MJL	JOB No.:	--
		APPROVED BY:	--	DWG. NO.:	TERRAIN-2
		DATE ISSUED:	05-13-22	SHEET:	2 OF 2

EXHIBIT: F  
SHEET: 8.5x11  
SHL: 19-1N-1W  
BHL-5: 20-1N-1W  
BHL-6: 20-1N-1W




Well SH-5: SPEYSIDE 5-19-20XHW  
Well SH-6: SPEYSIDE 6-19-20XHM

PROPOSED ACCESS ROAD VAN FIELDS, ELFREDA ET AL = 368' | 22.30 RODS (TOTAL)  
PROPOSED ACCESS ROAD JOHNNY LEE WARREN & BRENDA KAY WARREN = 764' | 46.30 RODS (TOTAL)  
PROPOSED ACCESS ROAD ALLAN B. HENSLEY = 188' | 11.39 RODS (TOTAL)  
PROPOSED ACCESS ROAD TOTAL = 1320' | 80.00 RODS (TOTAL)

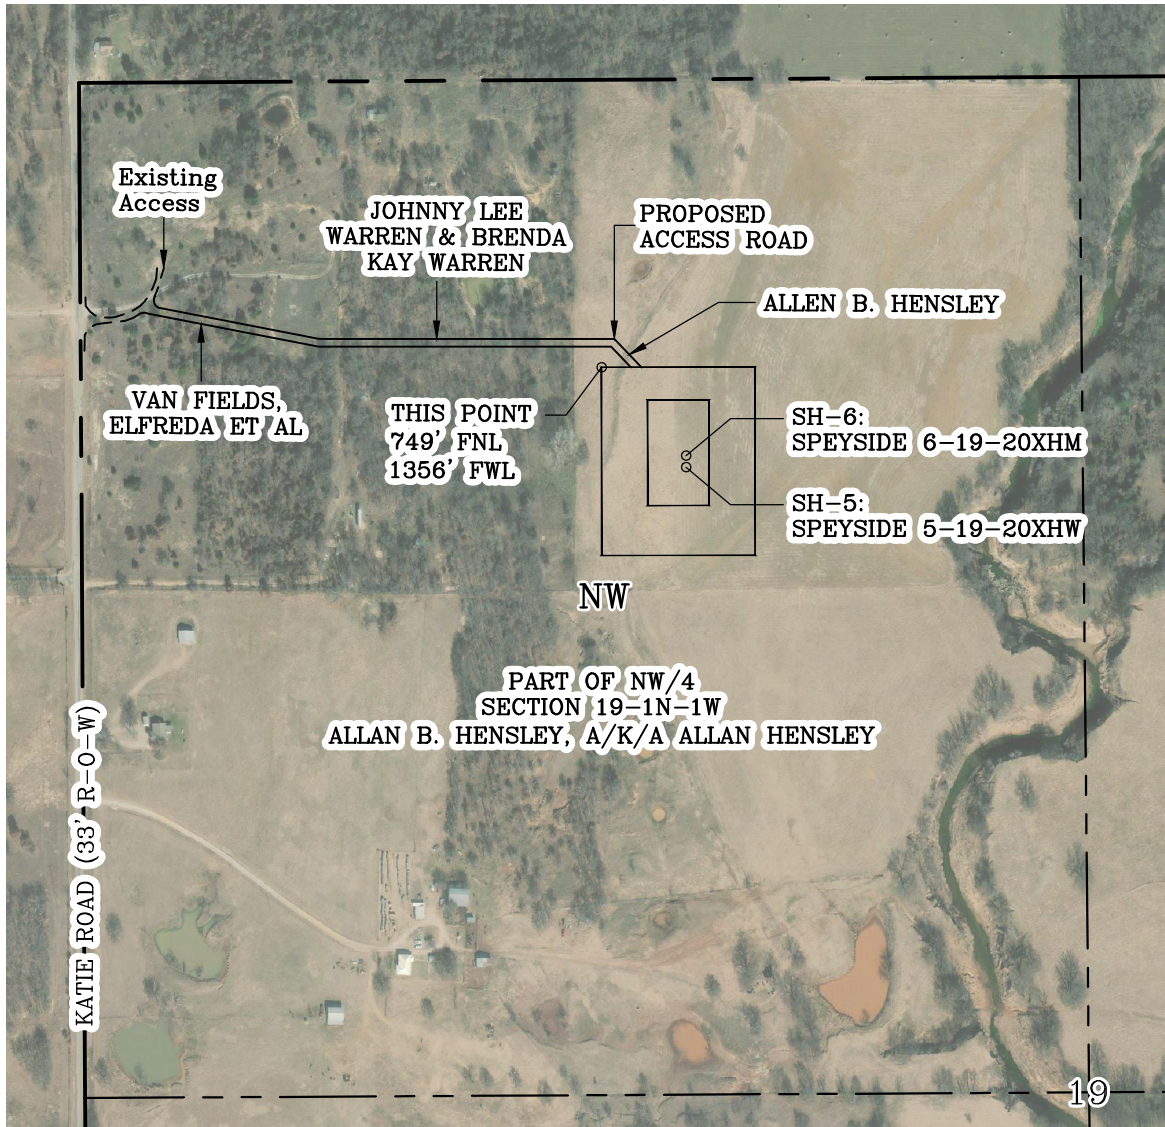

GPS DATUM - NAD83, OK SOUTH ZONE  
US FEET SCALE: 1" = 500'

Section 19 Township 1N Range 1W I.M.  
County GARVIN State OK  
Operator CONTINENTAL RESOURCES, INC.

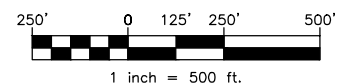


1 inch = 500 ft.


CURRENT REV.: 0

Prepared By:  PSLS 14612 Bogert Parkway. Oklahoma City, OK 73134	AERIAL PLAT	DRAWN BY:	HDG	SCALE:	1" = 500'
		CHECKED BY:	MJL	JOB No.:	--
		APPROVED BY:	--	DWG. NO.:	AERIAL-1
		DATE ISSUED:	05-13-22	SHEET:	1 OF 4

EXHIBIT: G  
 SHEET: 8.5x11  
 SHL: 19-1N-1W  
 BHL-5: 20-1N-1W  
 BHL-6: 20-1N-1W

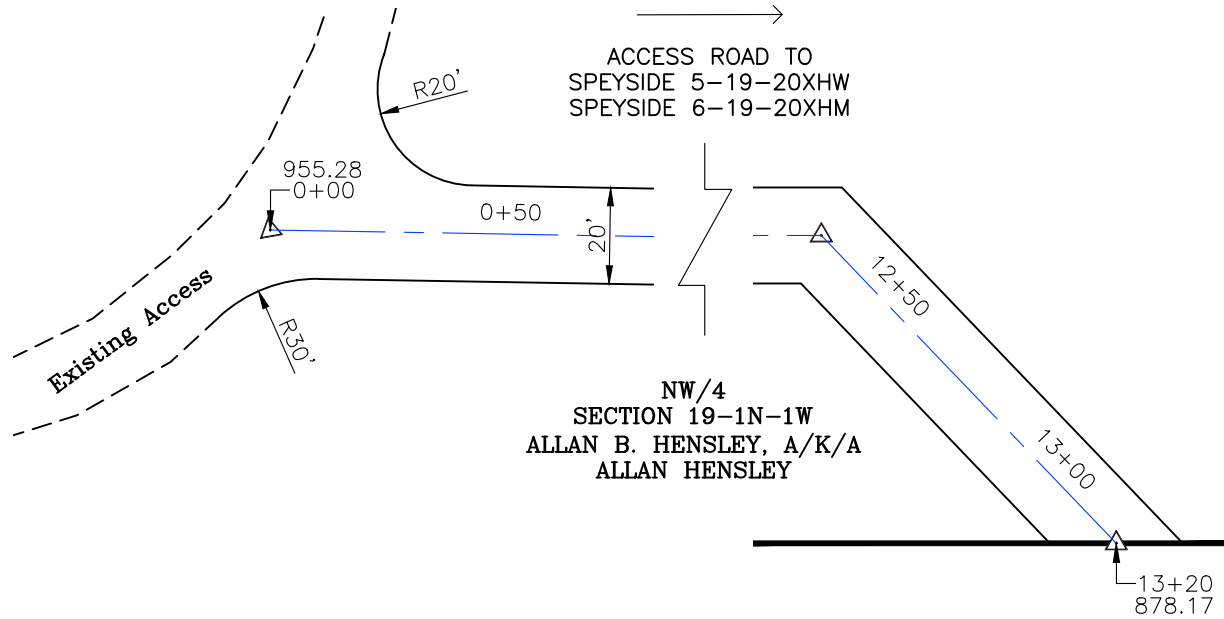

GPS DATUM - NAD83, OK SOUTH ZONE  
 US FEET SCALE: 1" = 40'


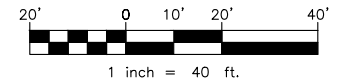


GPS DATUM - NAD83, OK SOUTH ZONE  
 US FEET SCALE: 1" = 40'

- \* THIS PROPOSED LEASE ROAD PLAT DOES NOT REPRESENT A TRUE BOUNDARY SURVEY.
- \* THE FOOTAGES AND TIES SHOWN HEREON ARE FROM LINES OF OCCUPATION AND MAY NOT BE FROM ACTUAL PROPERTY CORNERS.

Well SH-5: SPEYSIDE 5-19-20XHW  
 Well SH-6: SPEYSIDE 6-19-20XHM

PROPOSED ACCESS ROAD = 1320' | 80.00 RODS (TOTAL)

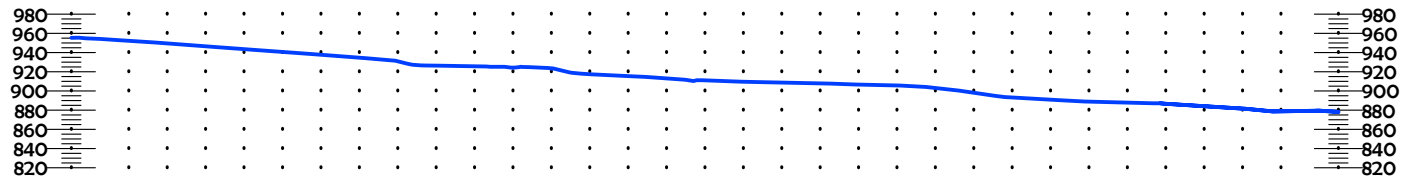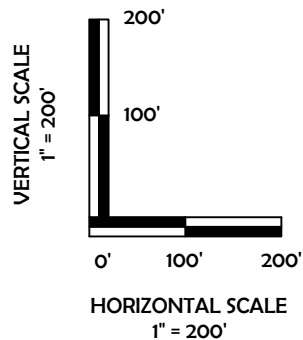

CURRENT REV.: 0

Prepared  
By:



PSLS  
 14612 Bogert Parkway  
 Oklahoma City, OK 73134



Continental  
RESOURCES

P.O. Box 26900  
 Oklahoma City  
 Oklahoma, 73126  
 (T) 1-800-256-8955  
 (F) 405-234-9253


## LEASE ROAD PLAN & PROFILE

DRAWN BY:	HDG	SCALE:	AS NOTED
CHECKED BY:	MJL	JOB No.:	--
APPROVED BY:	--	DWG. NO.:	P&P
DATE ISSUED:	05-13-22	SHEET:	2 OF 4

EXHIBIT: H  
 SHEET: 8.5x11  
 SHL: 19-1N-1W  
 BHL-5: 20-1N-1W  
 BHL-6: 20-1N-1W



Well SH-5: SPEYSIDE 5-19-20XHW  
 Well SH-6: SPEYSIDE 6-19-20XHM

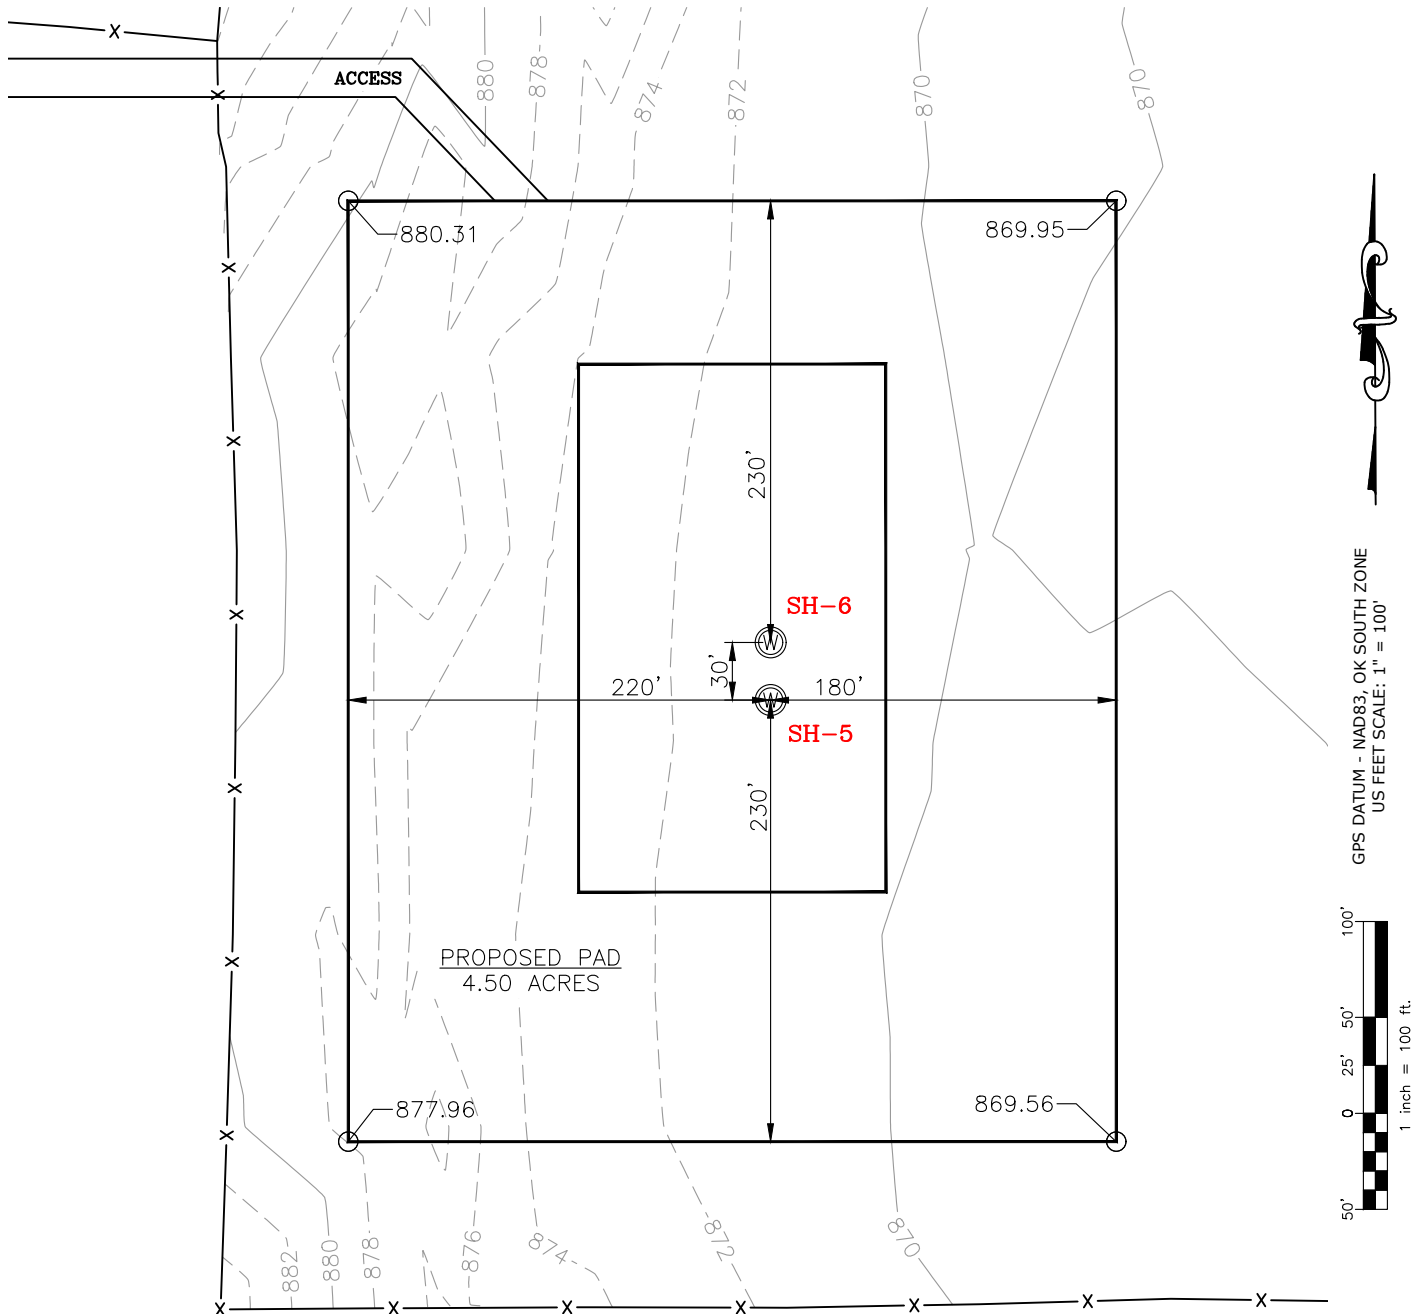

CURRENT REV.: 0


Prepared By:  PSLS 14612 Bogert Parkway. Oklahoma City, OK 73134	<b>EXISTING GRADING PLAN</b>	DRAWN BY:	HDG	SCALE:	1" = 100'
		CHECKED BY:	MJL	JOB No.:	--
		APPROVED BY:	--	DWG. NO.:	EX-GR.
		DATE ISSUED:	05-13-22	SHEET:	3 OF 4

EXHIBIT: I  
SHEET: 8.5x11  
SHL: 19-1N-1W  
BHL-5: 20-1N-1W  
BHL-6: 20-1N-1W



Well SH-5: SPEYSIDE 5-19-20XHW  
Well SH-6: SPEYSIDE 6-19-20XHM

TOTAL PROPOSED DISTURBED AREA: 5.67 ACRES

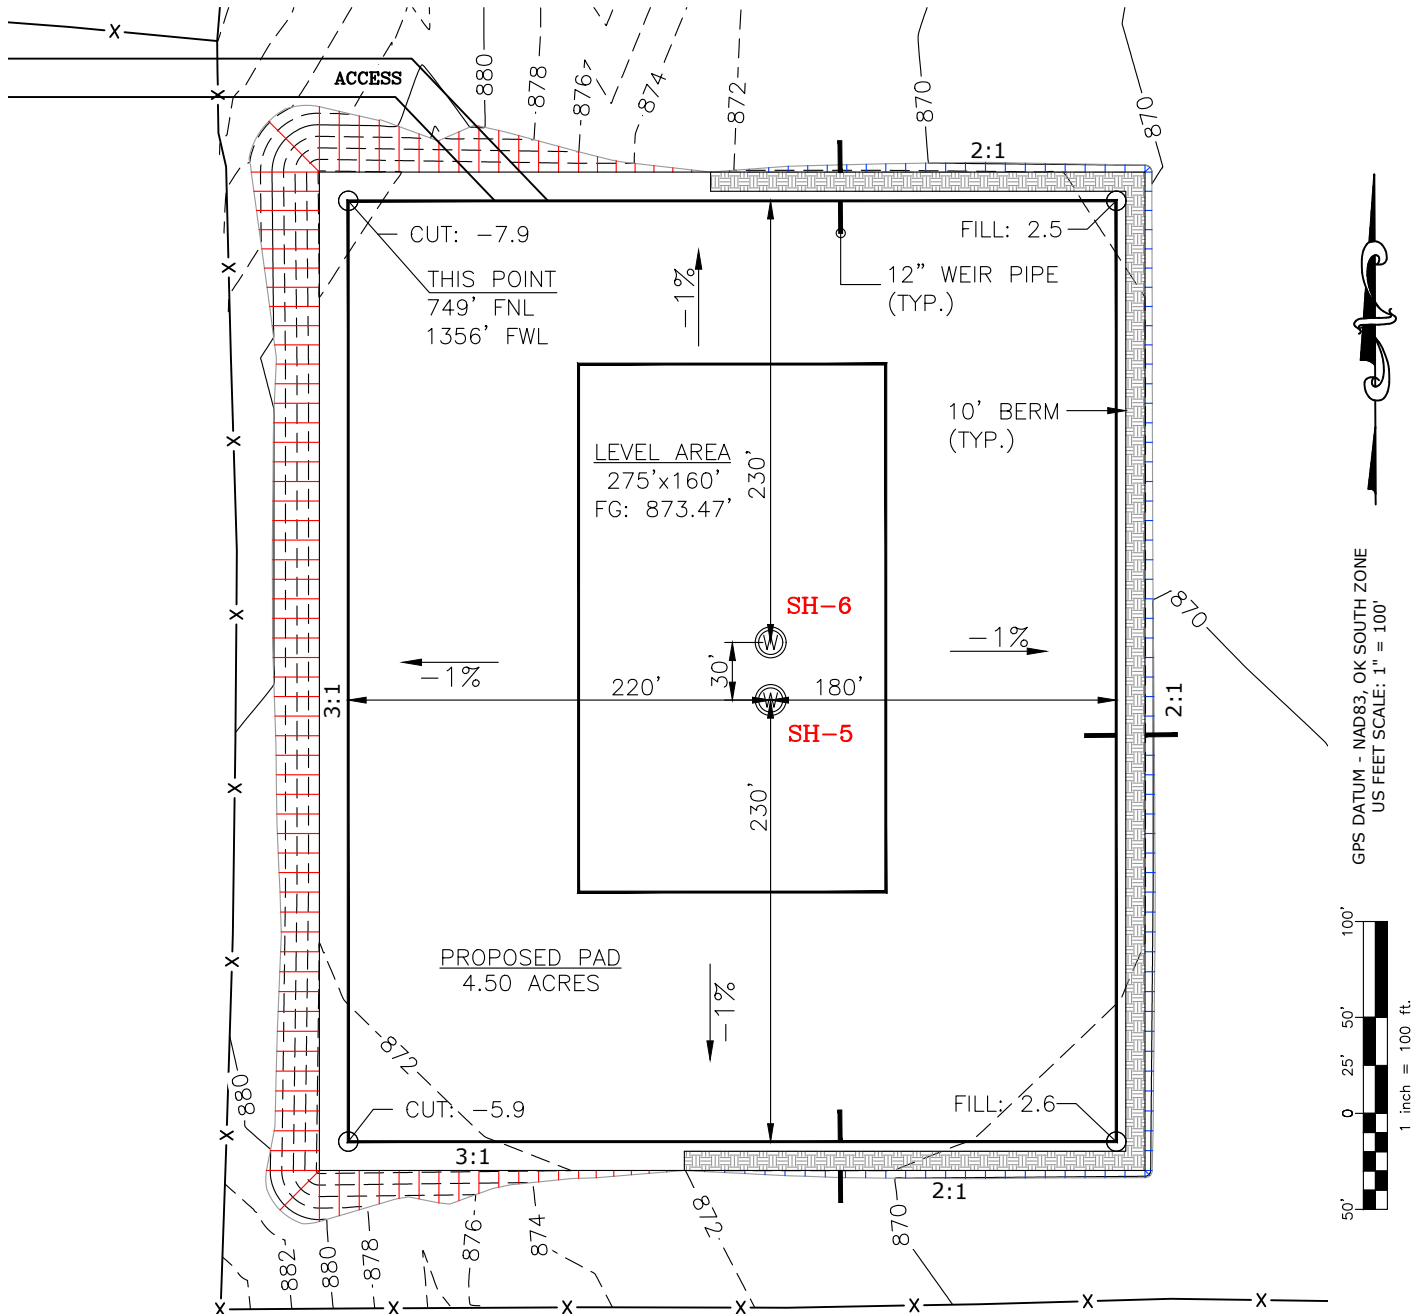

CUT VOLUME 10942.37 CU. YD. | 6" OF STRIPPED TOP SOIL: 4,573.19 CU. YD.  
FILL VOLUME 10940.67 CU. YD. | BERM LENGTH: 966' (647.22 CU. YD.)

(CUT/FILL VOLUMES DO NOT INCLUDE 6" OF STRIPPED TOP SOIL)

CURRENT REV.: 0

Prepared By:  PSLS 14612 Bogert Parkway, Oklahoma City, OK 73134	<b>PROPOSED GRADING PLAN</b>	DRAWN BY:	HDG	SCALE:	1" = 100'
		CHECKED BY:	MJL	JOB No.:	--
		APPROVED BY:	--	DWG. NO.:	PRO-GR.
		DATE ISSUED:	05-13-22	SHEET:	4 OF 4

EXHIBIT "A"


TABLE OF QUANTITIES

DISTURBED AREA = 5.67 ACRES  
ACCESS ROAD = ±188'

LOCATED ON THE LANDS OF:

ALLAN B. HENSLEY, A/K/A  
ALLAN HENSLEY

PART OF NW/4 SEC 19-1N-1W  
GARVIN COUNTY, OKLAHOMA

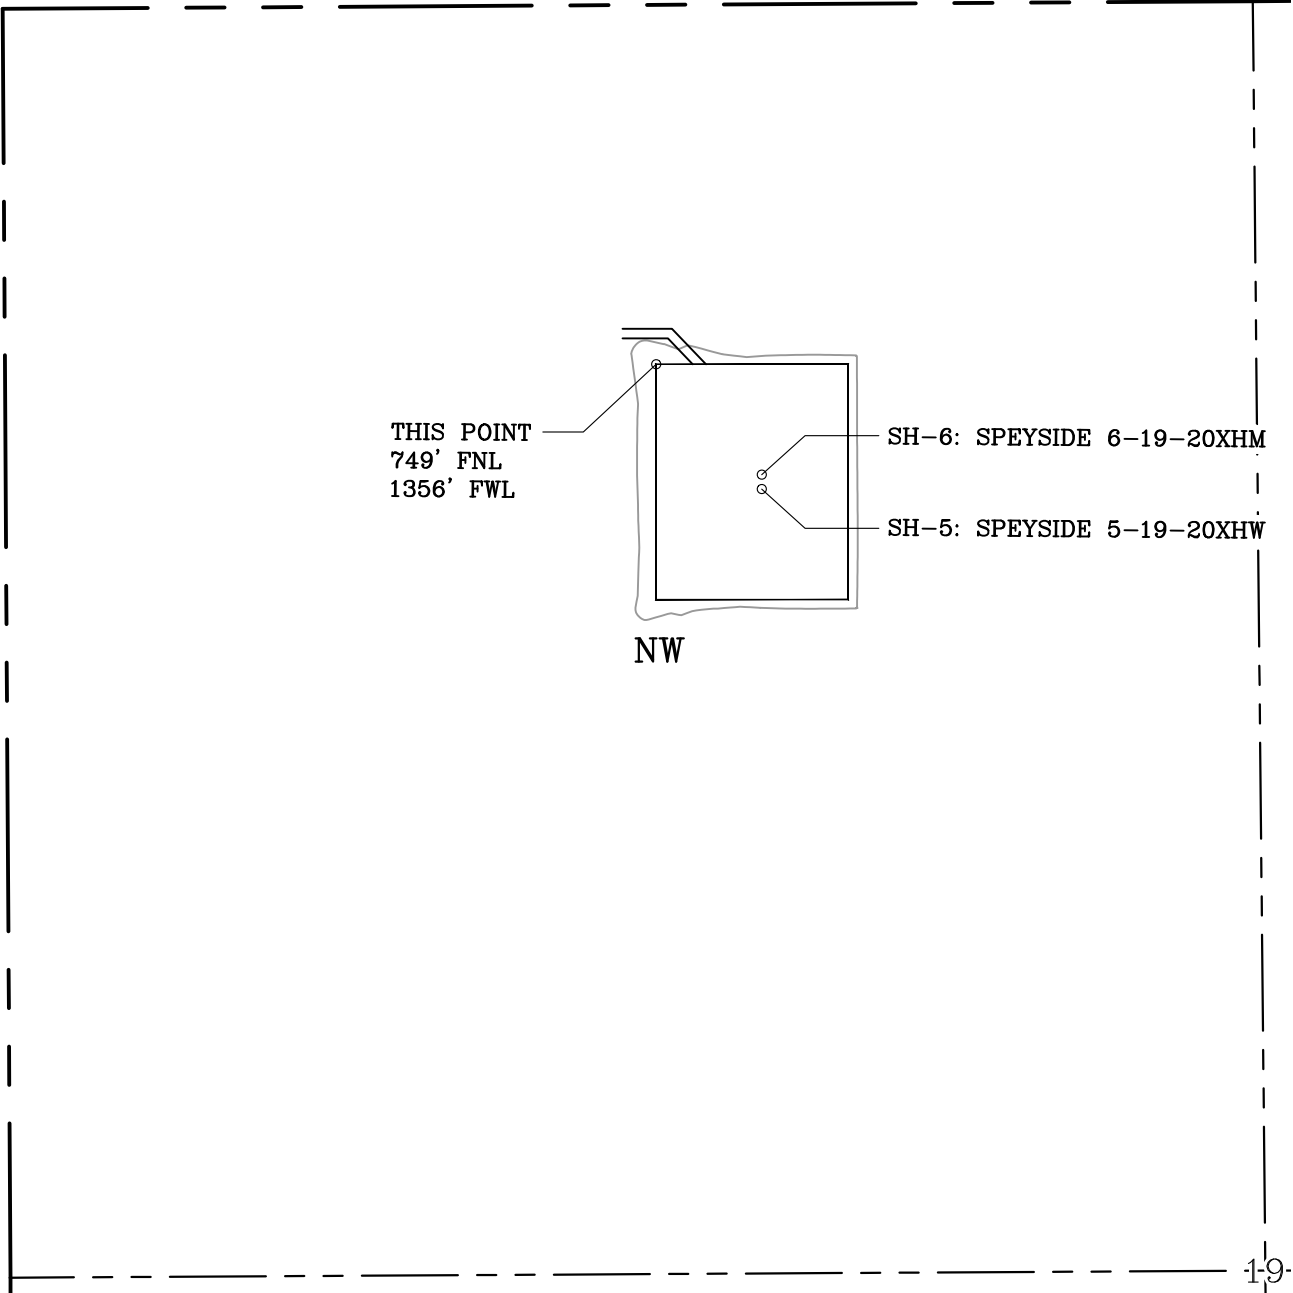

GENERAL NOTES:

- 1. THIS IS NOT A BOUNDARY SURVEY.
- 2. THIS SURVEY DOES NOT GUARANTEE TITLE OR OWNERSHIP.

<b>LEGEND</b>			PREPARED BY:		Drawn By: HDG	Date: 05-13-22	
	PROPOSED WELL PAD			PROPOSED DISTURBED AREA	Checked By: MJL	Scale: 1" = 400'	
					Sheet Size: 8.5x14	Sheet No. 1 of 1	
		GPS DATUM - NAD83, OK SOUTH ZONE US FEET SCALE: 1" = 400'	  PSLS 14612 BOGERT PARKWAY Oklahoma City, OK 73134		REV.	Description	Date
					0	ISSUED FOR APPROVAL	05-13-22

EXHIBIT "A"


TABLE OF QUANTITIES

ACCESS ROAD = ±764'

LOCATED ON THE LANDS OF:

JOHNNY LEE WARREN &  
BRENDA KAY WARREN

PART OF NW/4 SEC 19-1N-1W  
GARVIN COUNTY, OKLAHOMA

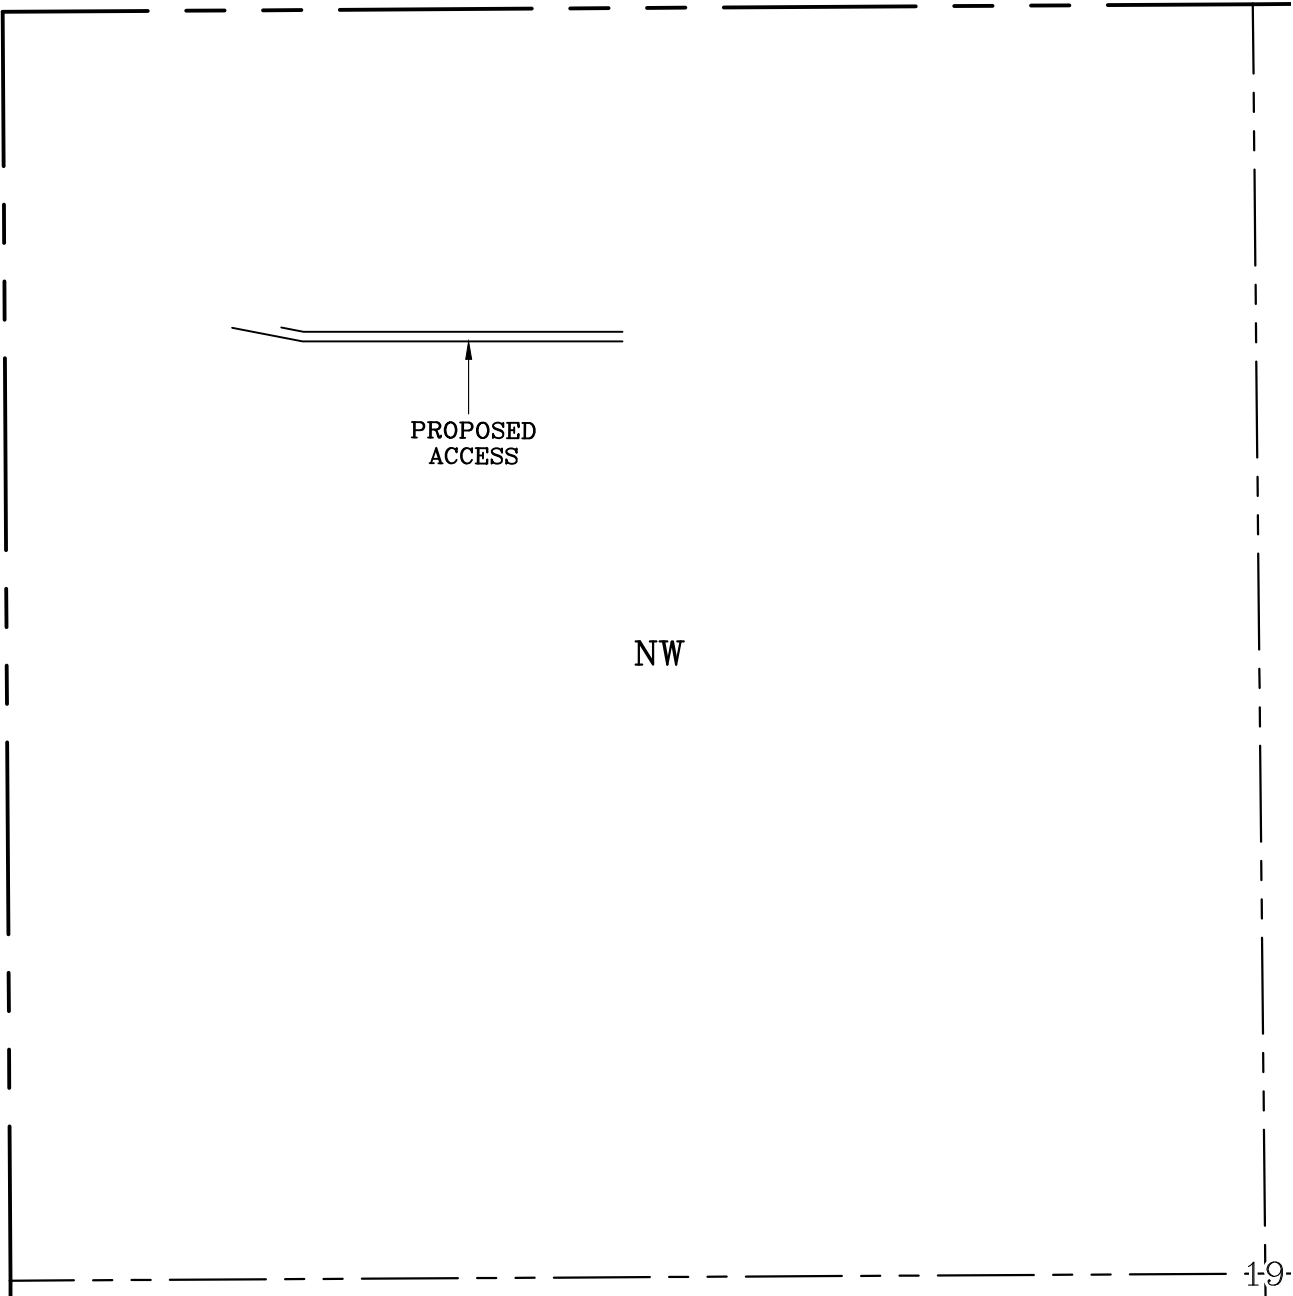

GENERAL NOTES:

- 1. THIS IS NOT A BOUNDARY SURVEY.
- 2. THIS SURVEY DOES NOT GUARANTEE TITLE OR OWNERSHIP.

**LEGEND**

PROPOSED WELL PAD

PROPOSED DISTURBED AREA

SECTION LINE

QUARTER SECTION LINE

1 inch = 400 ft.

PREPARED BY:

PSLS  
14612 BOGERT PARKWAY  
Oklahoma City, OK 73134

Drawn By:	HDG	Date:	05-13-22
Checked By:	MJL	Scale:	1" = 400'
Sheet Size:	8.5x14	Sheet No.	1 of 1
REV.	Description	Date	
0	ISSUED FOR APPROVAL	05-13-22	


EXHIBIT "A"

TABLE OF QUANTITIES

ACCESS ROAD = ±368'  
EXISTING ROAD = ±161'

LOCATED ON THE LANDS OF:  
VAN FIELDS, ELFREDA ET AL

PART OF NW/4 SEC 19-1N-1W  
GARVIN COUNTY, OKLAHOMA

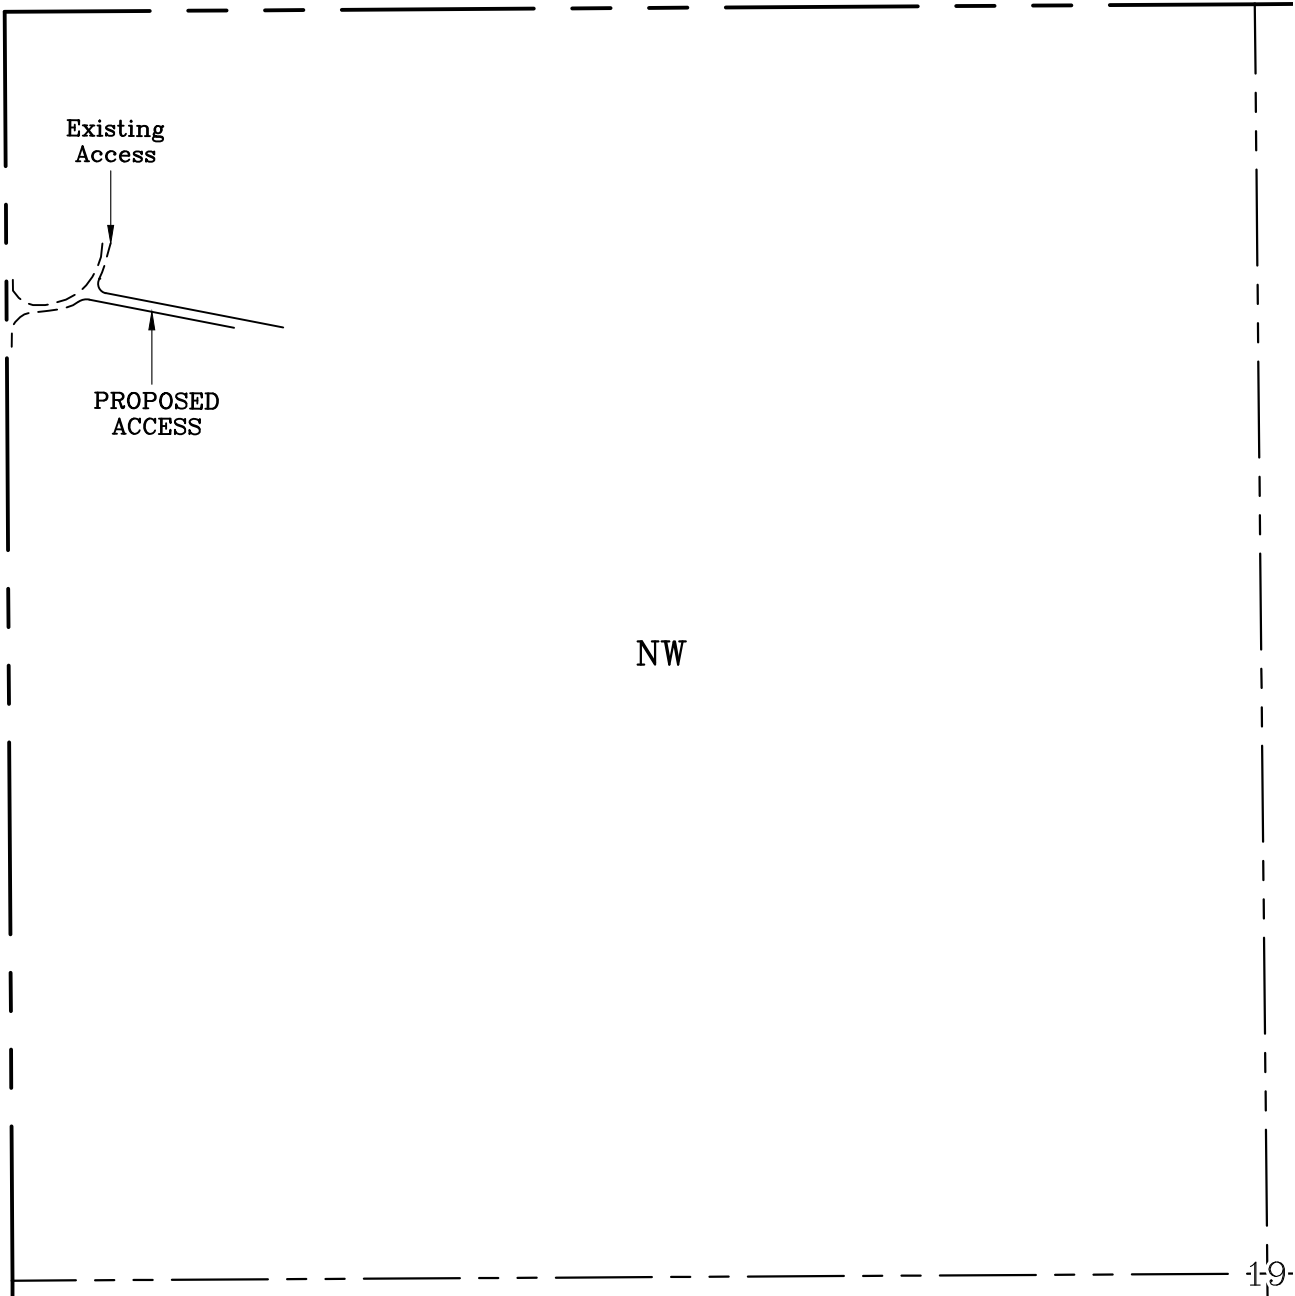

GENERAL NOTES:

- 1. THIS IS NOT A BOUNDARY SURVEY.
- 2. THIS SURVEY DOES NOT GUARANTEE TITLE OR OWNERSHIP.

**LEGEND**

	PROPOSED WELL PAD		PROPOSED DISTURBED AREA
	SECTION LINE		QUARTER SECTION LINE

GPS DATUM -  
NAD83, OK SOUTH ZONE  
US FEET SCALE: 1" = 400'

PREPARED BY:

PSLS  
14612 BOGERT PARKWAY  
Oklahoma City, OK 73134

Drawn By:	HDG	Date:	05-13-22
Checked By:	MJL	Scale:	1" = 400'
Sheet Size:	8.5x14	Sheet No.	1 of 1
REV.	Description	Date	
0	ISSUED FOR APPROVAL	05-13-22	