API NUMBER: 019 26490

OKLAHOMA CORPORATION COMMISSION OIL & GAS CONSERVATION DIVISION P.O. BOX 52000 OKLAHOMA CITY, OK 73152-2000 (Rule 165:10-3-1)

Approval Date: 06/13/2022
Expiration Date: 12/13/2023

Multi Unit Oil & Gas

PERMIT TO DRILL

WELL LOCATION: Section: 09 Township: 2S Range: 3W	County: CARTER
SPOT LOCATION: N2 SW NW SW FEET FROM QUARTER: FR	M SOUTH FROM WEST
SECTION LINES:	1810 330
Lease Name: THUNDERBALL Wel	No: 1-9-4XHM Well will be 330 feet from nearest unit or lease boundary.
	·
Operator Name: CONTINENTAL RESOURCES INC Teleph	one: 4052349000; 4052349000; OTC/OCC Number: 3186 0
CONTINENTAL RESOURCES INC	DENNIS A CAMP
CONTINENTAL RESOURCES INC	
	259 HALLMARK ROAD
OKLAHOMA CITY, OK 73126-8870	RATLIFF CITY OK 73481
Formation(a) (Parmit Valid for Listed Formations Only):	
Formation(s) (Permit Valid for Listed Formations Only):	
Name Code Dept	
1 SYCAMORE 352SCMR 1017	
Spacing Orders: 399677 Location E	xception Orders: No Exceptions Increased Density Orders: No Density
Pending CD Numbers: 202202023 Workin	g interest owners' notified: *** Special Orders: No Special
202202024	g
202202025	
202202026	
Total Depth: 17193 Ground Elevation: 1044 Surfa	ce Casing: 1500 Depth to base of Treatable Water-Bearing FM: 1200
Total Depth: 17193 Ground Elevation: 1044 Surfa	Depth to base of Treatable Water-Bearing FM: 1200 Deep surface casing has been approved
	Deep surface casing has been approved
Total Depth: 17193 Ground Elevation: 1044 Surfa Under Federal Jurisdiction: No Fresh Water Supply Well Drilled: No	Deep surface casing has been approved Approved Method for disposal of Drilling Fluids:
Under Federal Jurisdiction: No	Deep surface casing has been approved Approved Method for disposal of Drilling Fluids: D. One time land application (REQUIRES PERMIT) PERMIT NO: 22-38235
Under Federal Jurisdiction: No Fresh Water Supply Well Drilled: No	Deep surface casing has been approved Approved Method for disposal of Drilling Fluids:
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Under Federal Jurisdiction: No Fresh Water Supply Well Drilled: No Surface Water used to Drill: Yes PIT 1 INFORMATION	Deep surface casing has been approved Approved Method for disposal of Drilling Fluids: D. One time land application (REQUIRES PERMIT) PERMIT NO: 22-38235 H. (Other) SEE MEMO Category of Pit: C Liner not required for Category: C Pit Location is: BED AQUIFER
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MULTI UNIT HOLE 1

Section: 4 Range: 3W Township: 2S Meridian: IM Total Length: 8389

County: CARTER Measured Total Depth: 17913 NWTrue Vertical Depth: 11412 Spot Location of End Point: N2 NW NW

> 1/4 Section Line: 50 Feet From: NORTH End Point Location from

Lease, Unit, or Property Line: 50 1/4 Section Line: 330 Feet From: WEST

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NOTES:	
Category	Description
DEEP SURFACE CASING	[6/13/2022 - G56] - APPROVED; NOTIFY OCC FIELD INSPECTOR IMMEDIATELY OF ANY LOSS OF CIRCULATION OR FAILURE TO CIRCULATE CEMENT TO SURFACE ON ANY CONDUCTOR OR SURFACE CASING
HYDRAULIC FRACTURING	[6/1/2022 - GC2] - OCC 165:10-3-10 REQUIRES:
	1) NOTICE SHALL BE GIVEN AT LEAST 5 BUSINESS DAYS PRIOR TO COMMENCEMENT OF HYDRAULIC FRACTURING OPERATIONS ON A HORIZONTAL WELL TO OPERATORS PRODUCING WELLS WITHIN 1 MILE OF THE COMPLETION INTERVAL OF THE SUBJECT WELL. THE NOTICE TO SUCH OPERATORS SHALL CONTAIN THE INFORMATION IN FORM 6000NOO. IF THE HYDRAULIC FRACTURING OPERATIONS SCHEDULE CHANGES AFTER NOTICE HAS BEEN PROVIDED, RESULTING IN A DELAY OF OPERATIONS OF MORE THAN 5 DAYS FROM THE INITIAL NOTICE, NEW NOTICE IS REQUIRED TO BE GIVEN;
	2) NOTICE WILL BE GIVEN TO THE OCC CENTRAL OFFICE AND LOCAL DISTRICT OFFICES AT LEAST 48 HOURS PRIOR TO COMMENCEMENT OF HYDRAULIC FRACTURING OPERATIONS. FORM 6000NHF SHALL BE USED AND IS FOUND AT THIS LINK: OCCEWEB.COM/OG/OGFORMS.HTML; AND,
	3) THE CHEMICAL DISCLOSURE OF HYDRAULIC FRACTURING INGREDIENTS FOR ALL WELLS IS TO BE REPORTED TO FRACFOCUS WITHIN 60 DAYS AFTER THE CONCLUSION OF HYDRAULIC FRACTURING OPERATIONS, FOUND AT FRACFOCUS.ORG
MEMO	[6/1/2022 - GC2] - CLOSED SYSTEM=STEEL PITS PER OPERATOR REQUEST, OBM RETURNED TO VENDOR, CUTTINGS PERMITTED PER DISTRICT
PENDING CD - 202202023	[6/10/2022 - G56] - (E.O.)(400)(HOR) N2, N2 SE4 4-2S-3W EST SCMR
	COMPL INT NCT 660' FB (COEXIST WITH SP # 112042)*** REC 6/10/2022 (P. PORTER)
	*** WILL BE ADDED AT HEARING PER ATTORNEY FOR OPERATOR;
PENDING CD - 202202024	[6/13/2022 - G56] - (E.O.) N2 9, SW4, S2 SE4 4-2S-3W X399677 SCMR 1 WELL NO OP NAMED REC 6/10/2022 (P. PORTER)
PENDING CD - 202202025	[6/13/2022 - G56] - (E.O.) N2 9, SW4, S2 SE4 4 & N2, N2 SE4 4-2S-3W X399677 SCMR N2 9 & SW4, S2 SE4 4-2S-3W X202202023 SCMR N2, N2 SE4 4-2S-3W X165:10-3-28(C)(2)(B) SCMR MAY BE CLOSER THAN 600' TO CITATION POWERS 2-4 WELL COMPL INT (N2 9 & SW4, S2 SE4 4-2S-3W) NCT 165' FSL, NCT 0' FNL, NCT 330' FWL COMPL INT (N2, N2 SE4 4-2S-3W) NCT 0' FSL, NCT 165' FNL, NCT 330' FWL NO OP NAMED REC 6/10/2022 (P. PORTER)
PENDING CD - 202202026	[6/13/2022 - G56] - (E.O.) N2 9, SW4, S2 SE4 4 & N2, N2 SE4 4-2S-3W EST MULTIUNIT HORIZONTAL WELL X399677 SCMR N2 9 & SW4, S2 SE4 4-2S-3W X202202023 SCMR N2, N2 SE4 4-2S-3W 66.67% N2 9 & SW4, S2 SE4 4-2S-3W 33.33% N2, N2 SE4 4-2S-3W NO OP NAMED REC 6/10/2022 (P. PORTER)
SPACING - 399677	[6/10/2022 - G56] - (560)(HOR)(IRR UNIT) SW4, S2 SE4, 4 & N2 9-2S-3W EST SCMR POE TO BHL NLT 660' FB (COEXIST WITH PROD NON HOR DR & SP UNITS, SUPERSEDE NON DEVELOPED NON HOR DR & SP UNITS)

EXHIBIT: A (1 of 6) SHEET: 8.5×14 SHL: <u>9-2S-3W</u> BHL-1: 4-2S-3W



WELL PAD ID: 4D45AB6A-F81E-6CAD-5A6C-5425426B6184

SH-1-ID: V2BIF21MFI

COVER SHEET

<u>CONTINENTAL RESOURCES, INC.</u> P.O. BOX 26900 OKLAHOMA CITY, OK 73126 * (T) 1-800-256-8955 (F) 405-234-9253

Section 9 Township 2S Range 3W I.M. SH-1: THUNDERBALL 1-9-4XHM

CARTER State OK

Operator _____CONTINENTAL RESOURCES, INC.

NAD-83							EXISTING	DESIGN
POINT	WELL NAME	NORTHING	EASTING	LATITUDE LONGITUDE	LATITUDE LONGITUDE		ELEVATION	ELEVATION
SH-1	THUNDERBALL 1-9-4XHM	386978	2111390	34° 23′ 44.78″ -97° 31′ 34.79″	34.395773 -97.526332	1810' FSL / 330' FWL (NE/4 SW/4 NW/4 SW/4 SEC 9)	1044.23'	1045.86
LP-1	LANDING POINT	387258	2111388	34° 23′ 47.55″ -97° 31′ 34.80″	34.396542 -97.526335	2090' FSL / 330' FWL (SW/4 SEC 9)		
3HL-1	BOTTOM HOLE LOCATION	395647	2111342	34° 25′ 10.54″ -97° 31′ 34.88″	34.419594 -97.526355	50' FNL / 330' FWL (NW/4 SEC 4)		
X-1	MCDANIEL #1	389446	2115986	34° 24' 08.97" -97° 30' 39.80"	34.402492 -97.511056	9-2S-3W: TD: 7600' 981' FNL / 326' FEL		
X-2	HAAS #1	388790	2115336	34° 24' 02.51" -97° 30' 47.60"	34.400698 -97.513222	9-2S-3W: TD: 7210' 1640' FNL / 981' FEL		
X-3	HASS #3	388788	2115996	34° 24' 02.47" -97° 30' 39.72"	34.400685 -97.511034	9-2S-3W: TD: 7886' 1639' FNL / 321' FEL		
X-4	HAAS #2	388068	2116002	34° 23′ 55.34″ -97° 30′ 39.70″	34.398706 -97.511027	9-2S-3W: TD: 6628' 2359' FNL / 321' FEL		
X-5	DENNIS CAMP/BUMPASS UNIT #182-1	388789	2114671	34° 24′ 02.53″ -97° 30′ 55.54″	34.400704 -97.515427	9-2S-3W: TD: 7860' 1643' FNL / 1646' FEL		
X-6	GRAY/BUMPASS UNIT #174-1	390114	2113346	34° 24′ 15.71″ -97° 31′ 11.28″	34.404364 -97.519800	9-2S-3W: TD: 7996' 322' FNL / 2310' FWL		
X-7	GRAY/BUMPASS UNIT #173-2	390116	2112686	34° 24′ 15.75″ -97° 31′ 19.16″	34.404376 -97.521988	9-2S-3W: TD: 7740' 323' FNL / 1650' FWL		
X-8	JENNINGS DEESE UNIT	386150	2115351	34° 23′ 36.40″ -97° 30′ 47.58″	34.393443 -97.513216	9-2S-3W: TD: 5335' 990' FSL / 985' FEL		
X-9	JENNINGS DEESE UNIT (HAAS 6) #10	385488	2116016	34° 23′ 29.82″ -97° 30′ 39.68″	34.391617 -97.511023	9-2S-3W: TD: 5356' 330' FSL / 324' FEL		
X-10	JENNINGS DEESE UNIT #12	385491	2114696	34° 23′ 29.91″ -97° 30′ 55.44″	34.391642 -97.515399	9-2S-3W: TD: 5500' 330' FSL / 1644' FEL		
X-11	JENNINGS DEESE (D CAMP 2) #2	386154	2113377	34° 23′ 36.53″ -97° 31′ 11.14″	34.393482 -97.519760	9-2S-3W: TD: 5540' 990' FSL / 2310' FWL		
X-12	H A BRADY/BUMPASS UNIT #177-1	389449	2114666	34° 24' 09.06" -97° 30' 55.56"	34.402517 -97.515432	9-2S-3W: TD: 7600' 983' FNL / 1646' FEL		
X-13	JENNINGS DSE. (HAAS 4) #11	385490	2115356	34° 23′ 29.87″ -97° 30′ 47.56″	34.391630 -97.513211	9-2S-3W: TD: 5406' 330' FSL / 984' FEL		
X-14	JENNINGS DEESE (CAMP 1) #13	385493	2114035	34° 23′ 29.96″ -97° 31′ 03.31″	34.391655 -97.517587	9-2S-3W: TD: 6500' 330' FSL / 2304' FEL		
X-15	JENNINGS DEESE UNIT (CAMP 3) #3	386153	2114031	34° 23′ 36.49″ -97° 31′ 03.33″	34.393469 -97.517592	9-2S-3W: TD: 5500' 990' FSL / 2305' FEL		
X-16	JENNINGS DSE. UT (CAMP 4) #4	386151	2114691	34° 23′ 36.44″ -97° 30′ 55.46″	34.393456 -97.515404	9-2S-3W: TD: 5350' 990' FSL / 1645' FEL		
X-17	JENNINGS DEESE UNIT (DENNIS CAMP 3) #1	386816	2112712	34° 23′ 43.11″ -97° 31′ 19.04″	34.395308 -97.521955	9-2S-3W: TD: 5500' 1650' FSL / 1650' FWL		
X-18	JENNINGS DEESE UNIT (D.CAMP 1) #14	385494	2113382	34° 23′ 30.00″ -97° 31′ 11.11″	34.391668 -97.519754	9-2S-3W: TD: 5514' 330' FSL / 2310' FWL		
X-19	EVMBSU (BUMPASS UNIT 198) #10WSW	389414	2114893	34° 24' 08.71" -97° 30' 52.86"	34.402420 -97.514683	9-2S-3W: TD: 2198' 1017' FNL / 1420' FEL		
X-20	JENNINGS DSE (CAMP DENNIS 4) #15	385497	2112062	34° 23′ 30.10″ -97° 31′ 26.87″	34.391693 -97.524129	9-2S-3W: TD: 5855' 330' FSL / 990' FWL		
X-21	JENNINGS DEESE UNIT #WSW87	385326	2115531	34° 23′ 28.24″ -97° 30′ 45.48″	34.391178 -97.512633	9-2S-3W: TD: 1900' 167' FSL / 810' FEL		
X-22	SMITH GRAY #1-9	388493	2112698	34° 23′ 59.70″ -97° 31′ 19.10″	34.399917 -97.521971	9-2S-3W: TD: 8400' 1946' FNL / 1650' FWL		
X-23	SMITH GRAY #2-9	388795	2111706	34° 24′ 02.74″ -97° 31′ 30.92″	34.400760 -97.525256	9-2S-3W: TD: 5400' 1647' FNL / 660' FWL		
X-24	NORTH CAMP #1	387473	2114021	34° 23′ 49.55″ -97° 31′ 03.37″	34.397096 -97.517603	9-2S-3W: TD: 5800' 2310' FSL / 2306' FEL		
X-25	S M MCDANIELS /A/ #2	390107	2115322	34° 24′ 15.55″ -97° 30′ 47.70″	34.404318 -97.513250	9-2S-3W: TD: 6250' 322' FNL / 986' FEL		
X-26	SSAD UNIT #4WSW	387336	2113226	34° 23′ 48.23″ -97° 31′ 12.87″	34.396731 -97.520241	9-2S-3W: TD: 2460' 2171' FSL / 2169' FWL		
X-27	H A BRADY #2	390110	2114051	34° 24′ 15.63″ -97° 31′ 02.86″	34.404343 -97.517461	9-2S-3W: TD: 6350' 324' FNL / 2256' FEL		
X-28	ASSAULT #1-9-16-21XHM	387526	2111343	34° 23′ 50.20″ -97° 31′ 35.33″	34.397277 -97.526480	9-2S-3W: TD: 19100' 2357' FSL / 287' FWL		
X-29	BUMPASS UNITSON #118	394728	2114644	34° 25′ 01.29″ -97° 30′ 55.53″	34.417025 -97.515424	4-2S-3W: TD: 6800' 990' FNL / 1643' FEL		
X-30	C JOHNSON #1	394058	2114646	34° 24° 54.66″ -97° 30° 55.54″	34.415183 -97.515426	4-2S-3W: TD: UNKNOWN' 1660' FNL / 1644' FEL		

Certificate of Authorization No. 7318



REVISIONS											
No.	DATE	STAKED	BY	DESCRIPTION	COMMENTS						
00	05-12-22	**-**-22	HDG	ISSUED FOR APPROVAL							
01	05-16-22	05-13-22	HDG	REV'D WELL NAME	REV'D ALL SHEETS						

EXHIBIT: A (2 of 6)

SHEET: 8.5×14

SHL: 9-2S-3W

BHL-1: 4-2S-3W



WELL PAD ID: 4D45AB6A-F81E-6CAD-5A6C-5425426B6184 SH-1-ID: V2BIF21MFI

X-31	BUMPASS UNIT (SUITOR 1) #106	395375	2115961	34° 25′ 07.62″ -97° 30′ 39.76″	34.418785 -97.511044	4-2S-3W: TD: UNKNOWN' 352' FNL / 321' FEL	
X-32	MINNIE SUITOR #1	395393	2115292	34° 25′ 07.83″ -97° 30′ 47.74″	34.418842 -97.513262	4-2S-3W: TD: 4605' 330' FNL / 990' FEL	
X-33	BUMPASS UNIT (POWERS 1) #104	395381	2113323	34° 25′ 07.81″ -97° 31′ 11.25″	34.418836 -97.519791	4-2S-3W: TD: 4138' 328' FNL / 2310' FEL	
X-34	BUMPASS UT(JOHNSON-SUITOR#2)	394716	2115304	34° 25′ 01.14″ -97° 30′ 47.65″	34.416984 -97.513235	4-2S-3W: TD: 6600' 1006' FNL / 983' FEL	
X-35	#119 BUMPASS UNIT (POWERS G.T.#4) #102	395382	2112763	34° 25′ 07.85″ -97° 31′ 17.93″	34.418847 -97.521648	4-2S-3W: TD: 6741' 324' FNL / 1750' FWL	
X-36	BUMPASS UNIT (POWERS G T 5) #116	394726	2111346	34' 25' 01.42" -97' 31' 34.89"	34.417061 -97.526358	4-2S-3W: TD: 7115' 972' FNL / 330' FWL	
X-37	BUMPASS UNIT(HENRY-GIBBENS#2)	391428	2112679	34° 24′ 28.74″ -97° 31′ 19.16″	34.407984 -97.521989	4-2S-3W: TD: 7600'	
X-38	#161 POWERS GT#8)BUMPASS	395367	2111344	34° 25′ 07.77″	34.418825 -97.526356	990' FSL / 1650' FWL 4-2S-3W: TD: 5012'	
X-39	#101 BUMPASS UNIT(POWERS	393404	2112011	-97° 31′ 34.88″ 34° 24′ 48.32″	34.413421	330' FNL / 330' FWL 4-2S-3W: TD: 5980'	
X-40	G.T.#6) #138 BUMPASS UNIT(POWERS-HENDON#2)	393401	2113331	-97° 31' 27.02" 34° 24' 48.22"	-97.524173 34.413396	2297' FNL / 990' FWL 4-2S-3W: TD: 4682'	
X-41	#140 BUMPASS UNIT(REDMOND	390759	2115318	-97° 31′ 11.27″ 34° 24′ 22.00″	-97.519796 34.406111	2308' FNL / 2310' FWL 4-2S-3W: TD: 6069'	
X-42	UNIT#4) #169 BUMPASS UNIT(POWERS	394724	2112006	-97° 30′ 47.71″ 34° 25′ 01.38″	-97.513252 34.417049	330' FSL / 986' FEL 4-2S-3W: TD: 4870'	
X-43	G.T.#7) #117 BUMPASS UNIT(BLAIR	394059	2113986	-97° 31′ 27.01″ 34° 24′ 54.71″	-97.524169 34.415196	977' FNL / 990' FwL 4-2S-3W: TD: 6800'	
X-44	R.L.#1) #127 BUMPASS UT. (REDMOND 1)	390762	2114658	-97' 31' 03.41" 34' 24' 22.05"	-97.517615 34.406126	1654' FNL / 2304' FEL 4-2S-3W: TD: 7500'	
X-45	#168 BUMPASS	390757	2115978	-97' 30' 55.58" 34' 24' 21.94"	-97.515440 34.406095	330' FSL / 1646' FEL 4-2S-3W: TD: 7400'	
X-46	UNIT(L.E.REDMOND#1) #170 GIDDENS L C #1	390766	2113376	-97° 30′ 39.83″ 34° 24′ 22.16″	-97.511064 34.406155	330' FSL / 326' FEL 4-2S-3W: TD: 6300'	
V 47	BUMPASS			-97' 31' 11.29" 34' 24' 35.22"	-97.519803 34.409783	330' FSL / 2310' FWL 4-2S-3W: TD: 6100'	
	UNIT(L.C.GIDDENS"A"#2) #157 BUMPASS UNIT(POWERS	392086	2113337	-97° 31′ 11.28″ 34° 25′ 07.86″	-97.519799 34.418849	2310' FSL / 1650' FWL 4-2S-3W: TD: 4238'	
X-48	G.T.#2) #103 BUMPASS UNIT (HENRY	395383	2112663	-97° 31′ 19.13″ 34° 24′ 35.32″	-97.521979 34.409812	323' FNL / 1650' FWL 4-2S-3W: TD: 6250'	
X-49	"A" 2) #155 BUMPASS	392091	2112017	-97° 31' 27.03" 34° 24' 48.04"	-97.524176 34.413344	1650' FSL / 990' FWL 4-2S-3W: TD: 6696'	
X-50	UNIT(JOHNSON"B"&"C"#1) #141 BUMPASS UT (SUITOR	393395	2115968	-97° 30′ 39.79″ 34° 25′ 07.72″	-97.511053 34.418811	2332' FNL / 325' FEL 4-2S-3W: TD: 6600'	
X-51	MINNIE 1) #105 BUMPASS UNIT (REDMOND	395378	2114641	-97° 30' 55.52" 34° 24' 41.53"	-97.515421 34.411536	340' FNL / 1641' FEL 4-2S-3W: TD: 6150'	
X-52	UNIT 6) #150 BUMPASS UNIT(C.JOHNSON#1)	392737	2115974	-97° 30′ 39.76″ 34° 25′ 01.10″	-97.511045 34.416971	2310' FSL / 323' FEL 4-2S-3W: TD: 3393'	
A=33	#120	394715	2115964	-97° 30′ 39.77″ 34° 25′ 01.19″	-97.511047 34.416997	1012' FNL / 323' FEL 4-2S-3W: TD: 3506'	
X-54	JOHNSON CHAS /A/ #1 EAST VELMA MIDDLE	394718	2114644	-97° 30′ 55.53″	-97.515424 34.405563	1000' FNL / 1643' FEL	
X-55	BLOCK SAND U #9WSW	390564	2116171	34° 24′ 20.03″ -97° 30′ 37.54″	-97.510428	4-2S-3W: TD: 2103' 138' FSL / 134' FEL	
X-56	EVMBSU (BUMPASS UNIT WSW 192) #8WSW	393178	2112029	34° 24′ 46.08″ -97° 31′ 26.82″	34.412800 -97.524117	4-2S-3W: TD: 2270' 1007' FSL / 2523' FWL	
X-57	BUMPASS UNIT #191	395415	2111493	34° 25′ 08.24″ -97° 31′ 33.09″	34.418955 -97.525859	4-2S-3W: TD: 2250' 283' FNL / 480' FWL	
X-58	BUMPASS UNIT #212	391877	2115974	34° 24′ 33.02″ -97° 30′ 39.81″	34.409173 -97.511059	4-2S-3W: TD: 4604' 1450' FSL / 326' FEL	
X-59	BUMPASS UNIT #211	392219	2115373	34° 24′ 36.44″ -97° 30′ 46.97″	34.410121 -97.513047	4-2S-3W: TD: 4750' 1790' FNL / 926' FEL	
X-60	BUMPASS UNIT #207	394057	2115206	34° 24′ 54.62″ -97° 30′ 48.85″	34.415172 -97.513570	4-2S-3W: TD: 4573' 1665' FNL / 1084' FEL	
X-61	BUMPASS UNIT #216	391417	2115976	34° 24′ 28.47″ -97° 30′ 39.82″	34.407909 -97.511061	4-2S-3W: TD: 4750' 990' FSL / 326' FEL	
X-62	TIVIS #1-4	394946	2115533	34° 25′ 03.40″ -97° 30′ 44.90″	34.417611 -97.512472	4-2S-3W: TD: 9300' 778' FNL / 752' FEL	
X-63	BUMPASS UNIT #205	395217	2111992	34° 25′ 06.25″ -97° 31′ 27.15″	34.418404 -97.524208	4-2S-3W: TD: 4573' 484' FNL / 978' FWL	
X-64	BUMPASS UNIT #206	394042	2115778	34° 24′ 54.45″ -97° 30′ 42.02″	34.415125 -97.511673	4-2S-3W: TD: 4080' 1684' FNL / 512' FEL	
X-65	BUMPASS UNIT #208	393396	2115308	34° 24′ 48.08″ -97° 30′ 47.67″	34.413357 -97.513241	4-2S-3W: TD: 4580' 2326' FNL / 985' FEL	
X-66	PEVEHOUSE #1-4H	392232	2111686	34° 24′ 36.74″ -97° 31′ 30.97″	34.410205 -97.525269	4-2S-3W: TD: 14402' 1790' FSL / 660' FWL	
X-67	WILLIAMS #1-4	394060	2113334	34° 24′ 54.74″ -97° 31′ 11.20″	34.415206 -97.519778	4-2S-3W: TD: 9975' 1649' FNL / 2315' FWL	
X-68	TIVIS #2-4	393478	2115390	34* 24' 48.89" -97* 30' 46.69"	34.413580 -97.512969	4-2S-3W: TD: 8640' 2245' FNL / 903' FEL	
X-69	BUMPASS UNIT #241	395115	2115776	34° 25′ 05.07″ -97° 30′ 41.98″	34.418074 -97.511662	4-2S-3W: TD: 6700' 611' FNL / 508' FEL	
X-70	POWERS #1-4	393961	2113344	34° 24′ 53.76″ -97° 31′ 11.08″	34.414934 -97.519745	4-2S-3W: TD: 9870' 1748' FNL / 2325' FWL	
X-71	BUMPASS (POWERS-HENDON UNIT#1) #139	393403	2112671	34° 24′ 48.27″ -97° 31′ 19.14″	34.413409 -97.521984	4-2S-3W: TD: 7180' 2303' FNL / 1650' FWL	
X-72	BUMPASS UNIT(HENRY-GIDDENS#1) #156	392088	2112677	34° 24′ 35.27″ -97° 31′ 19.16″	34.409798 -97.521988	4-2S-3W: TD: 7500' 1650' FSL / 1650' FEL	
	BUMPASS UNIT #190	392084	2113993	34° 24′ 35.16″ -97° 31′ 03.44″	34.409768 -97.517623	4-2S-3W: TD: 7300' 1650' FSL / 2306' FEL	
X-73					34.416798	4-2S-3W: TD: 9810'	
X-73	POWERS #2-4	394632	2111760	34° 25′ 00.47″ -97° 31′ 29.95″	-97.524985	1068' FNL / 744' FWL	

EXHIBIT: A (3 of 6)

SHEET: 8.5x14
SHL: 9-2S-3W
BHL-1: 4-2S-3W



WELL PAD ID: 4D45AB6A-F81E-6CAD-5A6C-5425426B6184

SH-1-ID: V2BIF21MFI

X-76	BUMPASS UNIT(POWERS-HERNSTAD#1 #137	393437	2111351	34° 24′ 48.67″ -97° 31′ 34.90″	34.413519 -97.526361	4-2S-3W: TD: 7350' 2261' FNL / 330' FWL	
X-77	BUMPASS UNIT(S.E.HENRY"A"#1) #166	390771	2112022	34° 24′ 22.27″ -97° 31′ 27.04″	34.406185 -97.524179	4-2S-3W: TD: 6510' 330' FSL / 990' FWL	
X-78	BUMPASS UNIT #242	393004	2115434	34° 24′ 44.20″ -97° 30′ 46.19″	34.412277 -97.512831	4-2S-3W: TD: 7100' 2575' FSL / 862' FEL	
X-79	TIPTON T H #1	394719	2113326	34° 25′ 01.26″ -97° 31′ 11.25″	34.417018 -97.519793	4-2S-3W: TD: 4235' 990' FNL / 2310' FEL	
X-80	POWERS G T #3	394715	2112666	34° 25′ 01.26″ -97° 31′ 19.13″	34.417016 -97.521981	4-2S-3W: TD: 4350' 990' FNL / 1650' FEL	
X-81	HENRY-GIDDENS U #4	391378	2112679	34° 24′ 28.25″ -97° 31′ 19.16″	34.407847 -97.521989	4-2S-3W: TD: 4800' 940' FSL / 1650' FWL	
X-82	REDMOND UNIT #2	392084	2113993	34° 24′ 35.16″ -97° 31′ 03.44″	34.409768 -97.517623	4-2S-3W: TD: 7300' 1650' FSL / 2306' FEL	
X-83	JOHNSON #2	394553	2114474	34° 24′ 59.57″ -97° 30′ 57.56″	34.416547 -97.515988	4-2S-3W: TD: 2500' 1164' FNL / 1813' FEL	
X-84	BUMPASS UNIT #209	392890	2115260	34° 24′ 43.07″ -97° 30′ 48.27″	34.411965 -97.513409	4-2S-3W: TD: 4604' 2460' FSL / 1036' FEL	
X-85	HENRY UNIT "B" #1	392093	2111357	34° 24′ 35.38″ -97° 31′ 34.91″	34.409827 -97.526364	4-2S-3W: TD: 7600' 1650' FSL / 330' FWL	
X-86	S.E. HENRY "D" #3	392714	2112639	34° 24′ 41.46″ -97° 31′ 19.57″	34.411516 -97.522102	4-2S-3W: TD: 4700' 2275' FSL / 1615' FWL	

EXHIBIT: A (4 of 6)

SHEET: 8.5x14

SHL: 9-2S-3W

BHL-1: 4-2S-3W



WELL PAD ID: 4D45AB6A-F81E-6CAD-5A6C-5425426B6184 SH-1-ID: V2BIF21MFI

NAD-27							EXISTING	DESIGN
H-1	THUNDERBALL 1-9-4XHM	386936	2142985	LONGITUDE 34° 23′ 44.47″	34.395686	1810' FSL / 330' FWL (NE/4 SW/4 NW/4 SW/4 SEC 9)	1044,23'	1045.86
P-1	LANDING POINT	387216	2142983	-97° 31′ 33.70″ 34° 23′ 47.24″	-97.526028 34.396455	2090' FSL / 330' FWL (SW/4 SEC 9)	1044.23	1043.86
HL-1	BOTTOM HOLE LOCATION	395605	2142938	-97° 31′ 33.71″ 34° 25′ 10.23″	-97.526031 34.419508	50' FNL / 330' FWL (NW/4 SEC 4)		
X-1		389403	2142936	-97' 31' 33.79" 34' 24' 08.66"	-97.526051 34.402405	9-2S-3W: TD: 7600'		
	MCDANIEL #1			-97' 30' 38.71" 34' 24' 02.20"	-97.510753 34.400611	981' FNL / 326' FEL 9-2S-3W: TD: 7210'		
(-2	HAAS #1	388747	2146931	-97° 30′ 46.51″ 34° 24′ 02.15″	-97.512919 34.400598	1640' FNL / 981' FEL 9-2S-3W: TD: 7886'		
(-3	HASS #3	388746	2147591	-97° 30′ 38.63″ 34° 23′ 55.03″	-97.510731 34.398619	1639' FNL / 321' FEL 9-2S-3W: TD: 6628'		
<-4	HAAS #2 DENNIS CAMP/BUMPASS	388026	2147597	-97° 30′ 38.61″ 34° 24′ 02.22″	-97.510724 34.400617	2359' FNL / 321' FEL 9-2S-3W: TD: 7860'		
	UNIT #182-1	388746	2146266	-97° 30′ 54.44″ 34° 24′ 15.40″	-97.515123 34.404277	1643' FNL / 1646' FEL 9-2S-3W: TD: 7996'		
(-6	GRAY/BUMPASS UNIT	390072	2144941	-97° 31' 10.19" 34° 24' 15.44"	-97.519496 34.404290	322' FNL / 2310' FWL 9-2S-3W: TD: 7740'		
(-7	GRAY/BUMPASS UNIT #173-2	390073	2144281	-97° 31′ 18.06″ 34° 23′ 36.08″	-97.521684 34.393356	323' FNL / 1650' FWL 9-2S-3W: TD: 5335'		
(-8	JENNINGS DEESE UNIT #5	386107	2146946	-97* 30' 46.49"	-97.512913	990' FSL / 985' FEL 9-2S-3W: TD: 5356'		
(-9	JENNINGS DEESE UNIT (HAAS 6) #10	385445	2147611	34' 23' 29.51" -97" 30' 38.59" 34' 23' 29.60"	34.391530 -97.510720	9-25-3W: TD: 5356 330' FSL / 324' FEL 9-2S-3W: TD: 5500'		
-10	JENNINGS DEESE UNIT #12	385448	2146291	-97° 30′ 54.34″	34.391555 -97.515095	9-25-3W: ID: 5500 330' FSL / 1644' FEL 9-2S-3W: TD: 5540'		
-11	JENNINGS DEESE (D CAMP 2) #2	386112	2144972	34° 23′ 36.22″ -97° 31′ 10.04″	34.393395 -97.519456	990' FSL / 2310' FWL		
-12	H A BRADY/BUMPASS UNIT #177-1	389406	2146262	34° 24′ 08.75″ -97° 30′ 54.46″	34.402431 -97.515129	9-2S-3W: TD: 7600' 983' FNL / 1646' FEL		
-13	JENNINGS DSE. (HAAS 4) #11	385447	2146951	34° 23′ 29.55″ -97° 30′ 46.47″	34.391542 -97.512907	9-2S-3W: TD: 5406' 330' FSL / 984' FEL		
-14	JENNINGS DEESE (CAMP 1) #13	385450	2145631	34° 23′ 29.65″ -97° 31′ 02.22″	34.391568 -97.517283	9-2S-3W: TD: 6500' 330' FSL / 2304' FEL		
-15	JENNINGS DEESE UNIT (CAMP 3) #3	386110	2145626	34° 23° 36.17″ -97° 31° 02.24″	34.393382 -97.517288	9-2S-3W: TD: 5500' 990' FSL / 2305' FEL		
-16	JENNINGS DSE. UT (CAMP 4) #4	386109	2146286	34° 23′ 36.13″ -97° 30′ 54.36″	34.393369 -97.515101	9-2S-3W: TD: 5350' 990' FSL / 1645' FEL		
-17	JENNINGS DEESE UNIT (DENNIS CAMP 3) #1	386773	2144307	34° 23′ 42.80″ -97° 31′ 17.94″	34.395221 -97.521651	9-2S-3W: TD: 5500' 1650' FSL / 1650' FWL		
-18	JENNINGS DEESE UNIT (D.CAMP 1) #14	385451	2144977	34° 23′ 29.69″ -97° 31′ 10.02″	34.391581 -97.519450	9-2S-3W: TD: 5514' 330' FSL / 2310' FWL		
-19	EVMBSU (BUMPASS UNIT 198) #10WSW	389372	2146488	34° 24' 08.40" -97° 30' 51.76"	34.402333 -97.514379	9-2S-3W: TD: 2198' 1017' FNL / 1420' FEL		
-20	JENNINGS DSE (CAMP DENNIS 4) #15	385454	2143657	34° 23' 29.78" -97° 31' 25.77"	34.391606 -97.523825	9-2S-3W: TD: 5855' 330' FSL / 990' FWL		
-21	JENNINGS DEESE UNIT #WSW87	385284	2147126	34° 23′ 27.93″ -97° 30′ 44.39″	34.391091 -97.512329	9-2S-3W: TD: 1900' 167' FSL / 810' FEL		
-22	SMITH GRAY #1-9	388450	2144294	34° 23′ 59.39" -97° 31′ 18.00"	34.399830 -97.521667	9-2S-3W: TD: 8400' 1946' FNL / 1650' FWL		
-23	SMITH GRAY #2-9	388753	2143301	34° 24′ 02.43" -97° 31′ 29.83"	34.400674 -97.524953	9-2S-3W: TD: 5400' 1647' FNL / 660' FWL		
-24	NORTH CAMP #1	387430	2145616	34° 23′ 49.23″ -97° 31′ 02.28″	34.397009 -97.517299	9-2S-3W: TD: 5800' 2310' FSL / 2306' FEL		
-25	S M MCDANIELS /A/ #2	390065	2146917	34° 24′ 15.23″ -97° 30′ 46.61″	34.404232 -97.512946	9-2S-3W: TD: 6250' 322' FNL / 986' FEL		
-26	SSAD UNIT #4WSW	387293	2144821	34° 23′ 47.92″ -97° 31′ 11.77″	34.396644 -97.519937	9-2S-3W: TD: 2460' 2171' FSL / 2169' FWL		
-27	H A BRADY #2	390067	2145647	34' 24' 15.32" -97' 31' 01.76"	34.404256 -97.517157	9-2S-3W: TD: 6350' 324' FNL / 2256' FEL		
-28	ASSAULT #1-9-16-21XHM	387483	2142938	34' 23' 49.88" -97' 31' 34.23"	34.397190 -97.526176	9-2S-3W: TD: 19100' 2357' FSL / 287' FWL		
-29	BUMPASS UNITSON #118	394686	2146239	34° 25' 00.98" -97° 30' 54.43"	34.416939 -97.515120	4-2S-3W: TD: 6800' 990' FNL / 1643' FEL		
-30	C JOHNSON #1	394015	2146241	34° 24′ 54.35″ -97° 30′ 54.44″	34.415097 -97.515123	4-2S-3W: TD: UNKNOWN' 1660' FNL / 1644' FEL		
-31	BUMPASS UNIT (SUITOR 1) #106	395332	2147556	34° 25' 07.31" -97° 30' 38.67"	34.418698 -97.510741	4-2S-3W: TD: UNKNOWN' 352' FNL / 321' FEL		
-32	MINNIE SUITOR #1	395350	2146888	34° 25′ 07.52″ -97° 30′ 46.65″	34.418756 -97.512958	4-2S-3W: TD: 4605' 330' FNL / 990' FEL		
-33	BUMPASS UNIT (POWERS	395339	2144919	34° 25′ 07.50″ -97° 31′ 10.15″	34.418750 -97.519487	4-2S-3W: TD: 4138' 328' FNL / 2310' FEL		
-34	BUMPASS UT(JOHNSON-SUITOR#2)	394674	2146899	34° 25′ 00.83″ -97° 30′ 46.55″	34.416898 -97.512932	4-2S-3W: TD: 6600' 1006' FNL / 983' FEL		
-35	#119 BUMPASS UNIT (POWERS G.T.#4) #102	395340	2144359	34° 25′ 07.54″ -97° 31′ 16.84″	34.418761 -97.521344	4-2S-3W: TD: 6741' 324' FNL / 1750' FWL		
-36	BUMPASS UNIT (POWERS G T 5) #116	394683	2142941	34° 25′ 01.11″ -97° 31′ 33.79″	34.416975 -97.526054	4-2S-3W: TD: 7115'		
-37	BUMPASS UNIT(HENRY-GIBBENS#2)	391386	2144274	34* 24' 28.43"	34.407897 -97.521685	972' FNL / 330' FWL 4-2S-3W: TD: 7600'		
-38	#161 POWERS GT#8)BUMPASS	395325	2142939	-97° 31′ 18.07″ 34° 25′ 07.46″	34.418738	990' FSL / 1650' FWL 4-25-3W: TD: 5012'		
-39	#101 BUMPASS UNIT(POWERS	393362	2143606	-97° 31′ 33.79″ 34° 24′ 48.01″	-97.526052 34.413335	330' FNL / 330' FWL 4-2S-3W: TD: 5980'		
-40	G.T.#6) #138 BUMPASS UNIT(POWERS-HENDON#2)	393359	2144926	-97° 31′ 25.93″ 34° 24′ 47.91″ -97° 31′ 10.17″	-97.523869 34.413309	2297' FNL / 990' FWL 4-2S-3W: TD: 4682'	-	

EXHIBIT: <u>A (5 of 6)</u>

 SHEET:
 8.5x14

 SHL:
 9-2S-3W

 BHL-1:
 4-2S-3W



WELL PAD ID: 4D45AB6A-F81E-6CAD-5A6C-5425426B6184

SH-1-ID: V2BIF21MFI

Section Company Comp						V L I	· SIILLI		
April	X-41		390717	2146913					
	X-42		394682	2143601			4-2S-3W: TD: 4870'		
Automatic Section Control Co	X-43	BUMPASS UNIT(BLAIR	394017	2145581	34" 24' 54.40"		4-2S-3W: TD: 6800'		
Company Comp	X-44	BUMPASS UT. (REDMOND 1)	390719	2146253	34" 24' 21.74"	34.406039	4-2S-3W: TD: 7500'		
Color Colo	X-45	BUMPASS	390714	2147573	34" 24' 21.63"	34.406009	4-2S-3W: TD: 7400'		
Company Comp	X-46		390724	2144937	34" 24' 21.85"	34.406069	4-2S-3W: TD: 6300'		
Color Colo	X-47	BUMPASS	392044	2144932	34° 24′ 34.91″	34.409696	4-2S-3W: TD: 6100'		
Color Colo		BUMPASS UNIT(POWERS			34° 25′ 07.55″	34.418763	4-2S-3W: TD: 4238'		
The content of the		BUMPASS UNIT (HENRY			34° 24′ 35.01″	34.409726	4-2S-3W: TD: 6250'		
Markets of Control 14000		"A" 2) #155 BUMPASS UNIT(10HNSON"B"&"C"#1)							
Montage 1971 1972		#141 BUMPASS UT (SUITOR							
Control Cont									
A-Sept A		UNIT 6) #150			-97° 30′ 38.67″		2310' FSL / 323' FEL		
A-55 BOST A-56 A-57		#120			-97° 30′ 38.68″	-97.510743	1012' FNL / 323' FEL		
N=50					-97° 30′ 54.43″	-97.515120	1000' FNL / 1643' FEL		
No. 120 200908 2010		BLOCK SAND U #9WSW			-97° 30′ 36.45″	-97.510124	138' FSL / 134' FEL		
X-85 BUMPASS UNIT #212 391835 2147089 37 24 32.00 47.75 30.0	X-56	WSW 192) #8WSW	393136		-97° 31′ 25.73″	-97.523813	1007' FSL / 2523' FWL		
X-50 BUMPASS UNIT #211 392177 214686 3-72 3-82 3-72 3-82	X-57	BUMPASS UNIT #191	395373	2143088	-97* 31' 32.00"	-97.525555	283' FNL / 480' FWL		
X=60 BUMPASS UNIT \$207 394014 214680	X-58	"	391835	2147569	-97° 30′ 38.72″	-97.510755	1450' FSL / 326' FEL		
X-61 BUMPASS UNIT #218 391375 214757 39130 43.78° 397.513265 392.58° 37.79° 39.75° 37.79° 39.75° 39.75° 392.58° 392.68° 392.	X-59	BUMPASS UNIT #211	392177	2146968	-97° 30′ 45.88″	-97.512743	1790' FNL / 926' FEL		
X=62 TINS #1-4 39403 214718 397 30 8373 797510787 990	X-60	BUMPASS UNIT #207	394014	2146801	-97° 30′ 47.76″	-97.513266	1665' FNL / 1084' FEL		
X=63 BUMPASS UNIT #205 395175 214588 347 25 0.058 34-21 0.05	X-61	BUMPASS UNIT #216	391375	2147571	-97° 30′ 38.73″	-97.510757	990' FSL / 326' FEL		
X-68 BUMPASS UNIT #206 394000 2147373 392-24 444-1878 397-30 4-25-300 10-4800 1	X-62	TIVIS #1-4	394903	2147128	-97° 30′ 43.81″	-97.512168	778' FNL / 752' FEL		
X-65 BUMPASS UNIT #208 393354 2146894 427 4777 4777	X-63	BUMPASS UNIT #205	395175	2143587	-97° 31′ 26.05″	-97.523904	484' FNL / 978' FWL		
X=66 DEVENOUSE #1-4H 392189 2143281 34° 24° 36.45° 34° 41018 4-25-3W TD: 19975 1 170° 1810° 1 1 1 1 1 1 1 1 1	X-64	BUMPASS UNIT #206	394000	2147373			1684' FNL / 512' FEL		
X=60	X-65	BUMPASS UNIT #208	393354	2146904					
X=69	X-66	PEVEHOUSE #1-4H	392189	2143281	34° 24′ 36.43″ -97° 31′ 29.88″	34.410118 -97.524966			
X=66	X-67	WILLIAMS #1-4	394018	2144929					
X-99 BUMPASS UNIT #241 3990/3 214/37 -97* 30' 40.89" -97.511358 611' FNL / 508' FEL	X-68	TIVIS #2-4	393436	2146985					
X-70 FUNITY # 39.98 214495 -97 31 09.99 -97.51941 1748' FNL 2325' FNL	X-69	BUMPASS UNIT #241	395073	2147371			4-2S-3W: TD: 6700' 611' FNL / 508' FEL		
X-71	X-70	POWERS #1-4	393918	2144939	34° 24′ 53.45″ -97° 31′ 09.99″	34.414848 -97.519441	4-2S-3W: TD: 9870' 1748' FNL / 2325' FWL		
X-72 UNIT(#ENRY-GIDDENS#1) 392046 2144272 34" 24" 34.98" 34.40971 1650" FSL 1650" FSL	X-71	UNIT#1) #139	393360	2144266					
X-74 POWERS #2-4 394589 2143356 3-97 31' 02.35' -97.517319 1650' FSL / 2306' FSL -1 -1	X-72	UNIT(HENRY-GIDDENS#1)	392046	2144272		34.409711 -97.521684			
X-75	X-73	BUMPASS UNIT #190	392041	2145588					
X-75	X-74	POWERS #2-4	394589	2143356					
X-76 UNIT(PORTS-HERNSTAP#] 393394 2142946	X-75	UNIT(S.E.HENRY"A"3) #160	391391	2142954					
X-77	X-76	UNIT(POWERS-HERNSTAD#1	393394	2142946					
X-79 TIPTON T H #1 394677 2144921 34* 25* 00.95* 34.416932 990* FNL / 2310* FEL	X-77	BUMPASS	390728	2143617			4-2S-3W: TD: 6510'		
X-79 TIPTON T H #1 394677 2144921 34° 25′ 00.95″ -97′ 31′ 10.16″ -97′ 519′ 439 4-2S-3W: TD: 4235′ 990′ FRL / 2310′ FEL X-80 POWERS G T #3 394673 2144261 34° 25′ 00.95″ -97′ 51′ 18.04″ -97′ 521677 34.416929 -97′ 521677 4-2S-3W: TD: 4255′ 990′ FRL / 2610′ FEL X-81 HENRY-GIDDENS U #4 391336 2144275 34′ 24′ 27.94″ -97′ 521685 4-2S-3W: TD: 4800′ 990′ FNL / 1650′ FWL X-82 REDMOND UNIT #2 392041 2145588 34′ 24′ 34.85″ -97′ 31′ 02.35″ -97′.517319 34′ 409881 -97′.517319 4-2S-3W: TD: 7300′ 10° FSL / 2306′ FEL	X-78	BUMPASS UNIT #242	392961	2147029					
X-80 POWERS G T #3 394673 2144261 34' 25' 00.95" -97' 31' 18.04" -97.521677 4-2S-3W: TD: 4350' 990' FNL / 1650' FEL X-81 HENRY-GIDDENS U #4 391336 2144275 -97' 31' 18.07" -97.521685 4-2S-3W: TD: 4800' 940' FSL / 1650' FWL X-82 REDMOND UNIT #2 392041 2145588 34' 24' 34.85" -97' 31' 02.35" -97.517319 34.409681 -97.517319 4-2S-3W: TD: 7300' 1650' FSL / 2306' FEL	X-79	TIPTON T H #1	394677	2144921			4-2S-3W: TD: 4235'		
X-81 HENRY-GIDDENS U #4 391336 2144275 34 24' 27.94"	X-80	POWERS G T #3	394673	2144261	34° 25' 00.95"		4-2S-3W: TD: 4350'		
X-82 REDMOND UNIT #2 392041 2145588 34' 24' 34.85" -97' 31' 02.35" -97.517319 4-2S-3W: TD: 7300'	X-81	HENRY-GIDDENS U #4	391336	2144275	34° 24' 27.94"	34.407760	4-2S-3W: TD: 4800'		
	X-82	REDMOND UNIT #2	392041	2145588	34° 24′ 34.85″	34.409681	4-2S-3W: TD: 7300'		
X-83 JOHNSON #2 394511 2146069 34' 24' 59.26' 34.416461 4-2S-3W: TD: 2500'	X-83	JOHNSON #2	394511	2146069	34" 24' 59.26"	34.416461	4-2S-3W: TD: 2500'		
X-84 BUMPASS UNIT #209 392847 2146855 34* 24* 42.76" 34.411878 4-2S-3W: TD: 4604*	X-84	BUMPASS UNIT #209	392847	2146855	34" 24' 42.76"	34.411878	4-2S-3W: TD: 4604'		
X-85 HENRY UNIT "B" #1 392051 2142952 34* 24* 35.07" 34.409741 4-2S-3W: TD: 7600*	X-85		392051	2142952	34" 24' 35.07"	34.409741	4-2S-3W: TD: 7600'		
Y_86 SF HENDY "n" #1 309671 2144234 34" 24" 41.15" 34.411429 4-25-3W: TD: 4700"	X-86	S.E. HENRY "D" #3	392671	2144234	34° 24′ 41.15″	34.411429	4-2S-3W: TD: 4700'		
X 50 S.E. M.H.H. 97 SEE / 1615' FWL -97' 31' 18.47" -97.521798 2275' FSL / 1615' FWL					97 31 10.4/	57.521790	22/3 FSE / 1013 FWE	<u> </u>	

PETRO LAND SERVICES SOUTH, LLC 14612 BOGERT PARKWAY, OKLA. CITY, OKLA. 73134 * OFFICE (405) 212-3108

Continental


EXHIBIT: <u>A (6 of 6)</u> 8.5x14 SHEET: 9 - 2S - 3WSHL:

BHL-1:

4-2S-3W

CARTER _ County Oklahoma 1810' FS<u>L</u>-330' FWL Section 2S Range 3W I.M. 9 Township

CONTINENTAL RESOURCES,INC (OPERATOR)

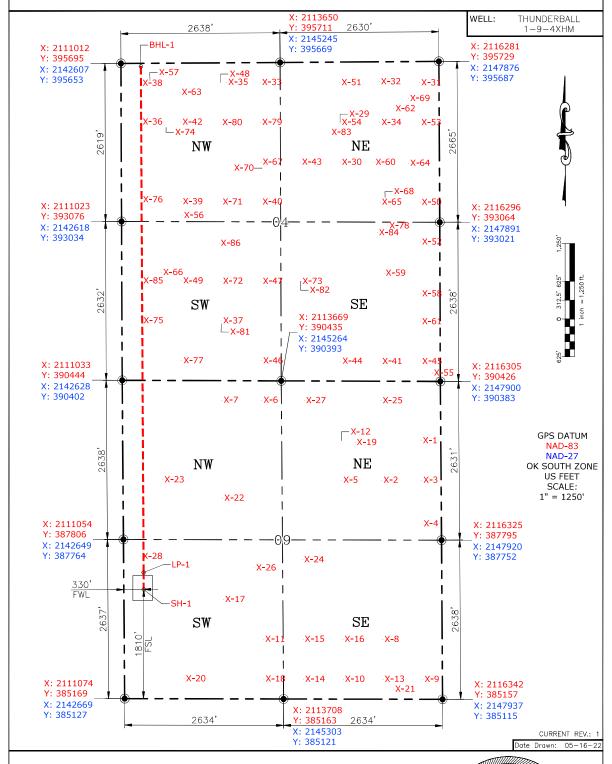

Please note that this location was staked on the ground under the supervision of a Licensed Professional Land Surveyor, but the accuracy of this survey is not guaranteed. Please contact PLS promptly if any inconsistency is determined. GPS data is observed from RTK-GPS. NOTE: X and Y data shown hereon for Section Corners may NOT have been surveyed on-the-ground, and further, does NOT represent a true Boundary Survey. Quarter Section distances may be assumed from a Government Survey Plat or assumed at a proportionate distance from opposing section corners, or occupation thereof, and may not have been measured on-the-ground, and further, does not represent a true Boundary Survey.

CERTIFICATE:

I, FRED A. SELENSKY, an Oklahoma Licensed Land Surveyor and an authorized agent of Petro Land Services South, LLC, do hereby certify to the information shown herein.



5-<u>16-22</u> Oklahoma PLS No.1860 DATE

EXHIBIT: ______B

SHEET: 8.5x11

SHL: 9-2S-3WBHL-1: 4-2S-3W


PETRO LAND SERVICES SOUTH, LLC

14612 BOGERT PARKWAY, OKLA. CITY, OKLA. 73134 * OFFICE (405) 212-3108 Certificate of Authorization No. 7318



CONTINENTAL RESOURCES,INC (OPERATOR)

100

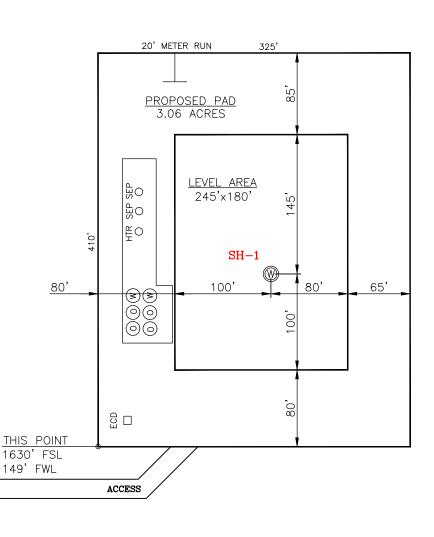



1 inch = 100 ft.

CURRENT REV.: 1

SH-1: THUNDERBALL 1-9-4XHM

DATUM: NAD-83

NORTHING: 386978

EASTING: 2111390

LAT: <u>N34°23'44.78"</u>

LONG: W97°31'34.79"

LAT: 34.395773°

LONG: -97.526332°

STATE PLANE COORDINATES

(US FEET): SOUTH

This Information Was Gathered With a GPS Receiver With ±1 Foot Horiz./Vert. Accuracy

Operator: CONTINENTAL RESOURCES, INC.

Lease Name: ___

Topography & Vegetation: Pasture

Good Drill Site? Yes Reference Stakes or Alternate Location Stakes Set:

Best Accessibility to Location: From The West Line

Distance & Direction From Hwy. or Town: Leaving Ratliff City, head south on SH-76 for 2.82 miles & continue south on Doral Rd. Continue south for 0.70 miles & turn right on Camp Rd. Head west for 1 mile & turn left on Owens Rd & head south

for 0.20 miles to the proposed access rd.

THE INFORMATION SHOWN HEREIN IS FOR CONSTRUCTION PURPOSES ONLY

LANDING POINT, BOTTOM HOLE AND DRILL PATH INFORMATION PROVIDED BY OPERATOR LISTED, NOT SURVEYED.

Well SH-1: THUNDERBALL 1-9-4XHM

Certificate of Authorization No. 7318



Prepared By: PSLS 14612 Bogert Parkway Oklahoma City, OK 73134 EXHIBIT: _____C


SHEET: 8.5x11

SHL: $\frac{9-2S-3W}{4-2S-3W}$





VICINITY MAP

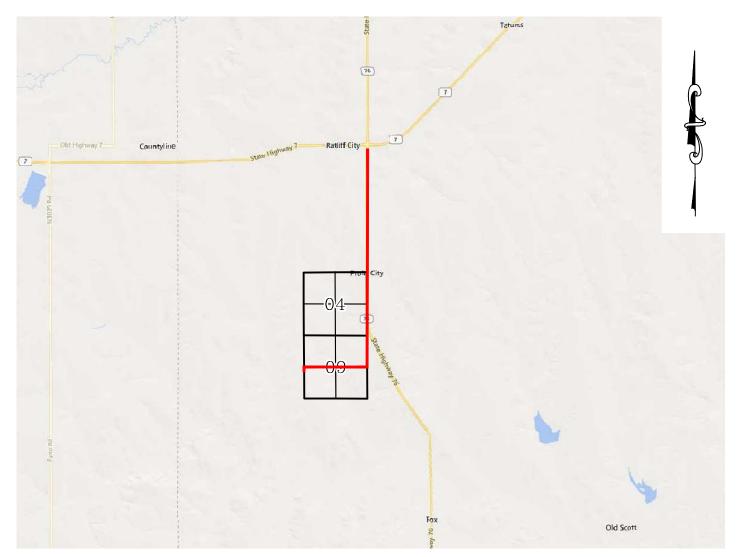

LEAVING RATLIFF CITY, HEAD SOUTH ON SH-76 FOR 2.82 MILES & CONTINUE SOUTH ON DORAL RD. CONTINUE SOUTH FOR 0.70 MILES & TURN RIGHT ON CAMP RD. HEAD WEST FOR 1 MILE & TURN LEFT ON OWENS RD & HEAD SOUTH FOR 0.20 MILES TO THE PROPOSED ACCESS RD.

CONTINENTAL RESOURCES, INC.

P.O. BOX 26900 OKLAHOMA CITY, OK 73126 * (T) 1-800-256-8955 (F) 405-234-9253



Prepared By: Petro Land Services South 14612 Bogert Parkway Oklahoma City, OK 73134

Section	9 Township	2SRange	3WI.M.	Well SH-1: THUN	NDERBALL 1-9-4XHM
County	CARTER	State	OK		

Operator _____CONTINENTAL RESOURCES, INC.

Well SH-1: THUNDERBALL 1-9-4XHM

EXHIBIT: _____D

SHEET: 8.5x11

SHL: 9-2S-3WBHL-1: 4-2S-3W



FACING NORTH



FACING SOUTH



CURRENT REV.: 1

Prepared By:



TERRAIN

DRAWN BY:	HDG	SCALE:	N.T.S.
CHECKED BY:	MJL	JOB No.:	
APPROVED BY:		DWG. NO.:	TERRAIN-1
DATE ISSUED:	05-16-22	SHEET:	1 OF 2

Well SH-1: THUNDERBALL 1-9-4XHM

EXHIBIT: ____E

SHEET: 8.5x11

SHL: 9-2S-3WBHL-1: 4-2S-3W



FACING EAST



FACING WEST



CURRENT REV.: 1

Prepared By:



TERRAIN

DRAWN BY:	HDG	SCALE:	N.T.S.
CHECKED BY:	MJL	JOB No.:	
APPROVED BY:		DWG. NO.:	TERRAIN-2
DATE ISSUED:	05-16-22	SHEET:	2 OF 2

EXHIBIT: F

SHEET: 8.5×11

SHL: $\frac{9-2S-3W}{4-2S-3W}$



PROPOSED ACCESS ROAD = 245' | 14.85 RODS (TOTAL)



Section $\underline{9}$ Township $\underline{2S}$ Range $\underline{3W}$ I.M.

County CARTER State OK

Operator CONTINENTAL RESOURCES, INC.



CURRENT REV.: 1

Prepared



AERIAL PLAT

DRAWN BY:	HDG	SCALE:	1" = 500'
CHECKED BY:	MJL	JOB No.:	
APPROVED BY:		DWG. NO.:	AERIAL-1
DATE ISSUED:	05-16-22	SHEET:	1 OF 4

GPS DATUM - NAD83, OK SOUTH ZONE US FEET SCALE: 1" = 500'

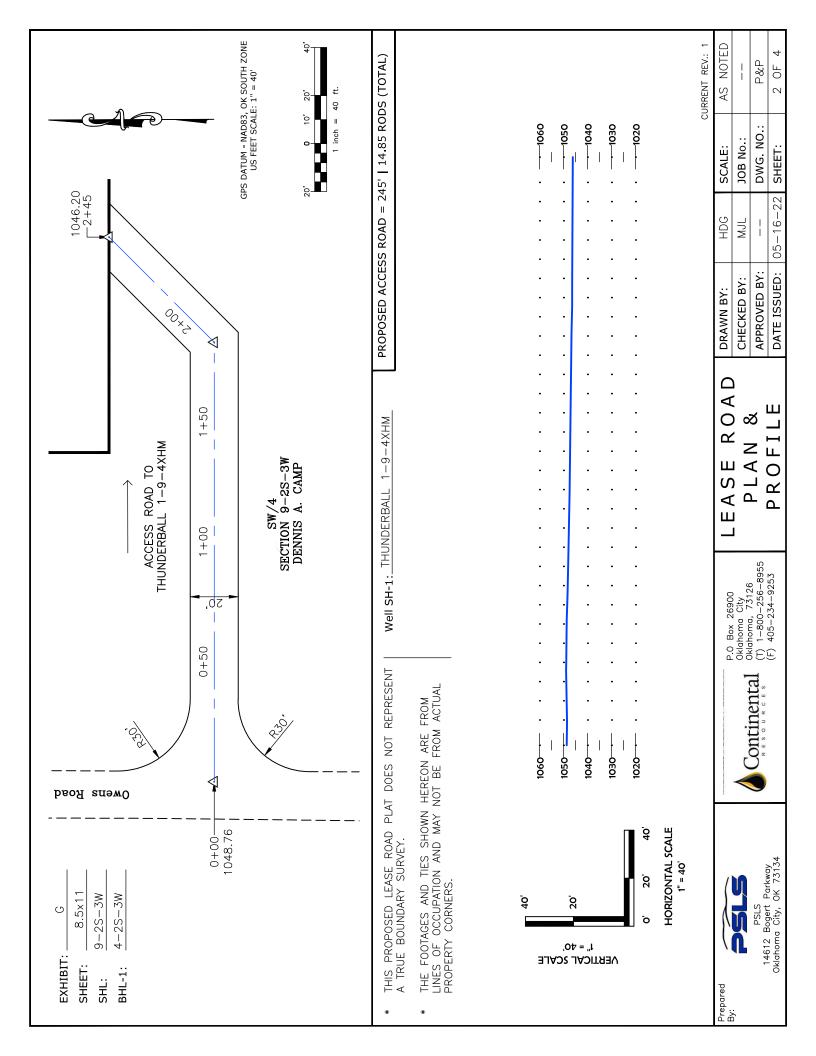



EXHIBIT: _____H

SHEET: 8.5x11

SHL: $\frac{9-2S-3W}{4-2S-3W}$



Well SH-1: THUNDERBALL 1-9-4XHM

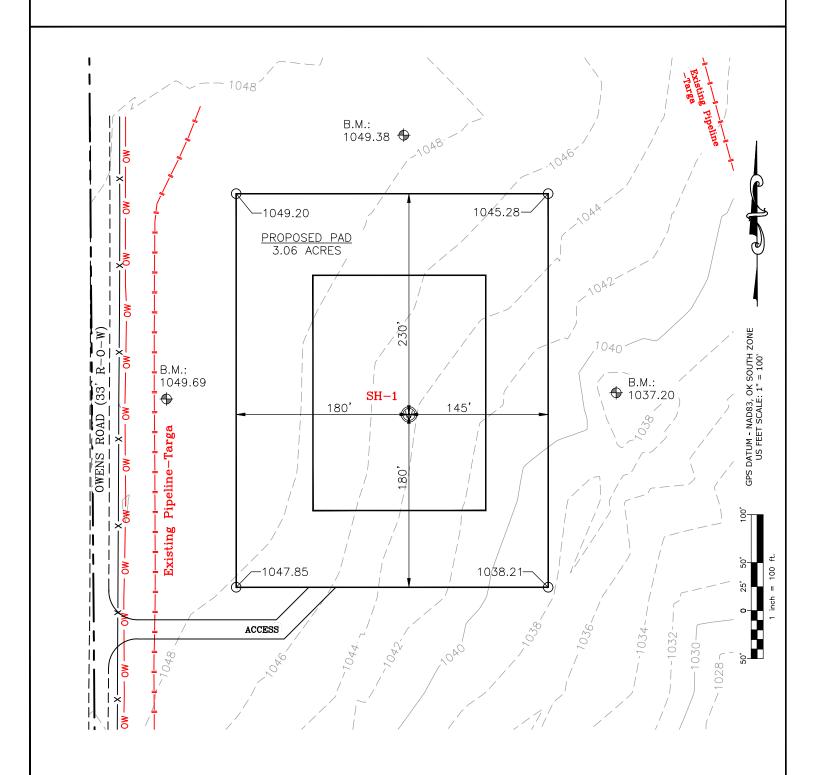

Prepared By:



EXISTING GRADING PLAN

DRAWN BY:	HDG	SCALE:	1" = 100'
CHECKED BY:	MJL	JOB No.:	
APPROVED BY:		DWG. NO.:	EX-GR.
DATE ISSUED:	05-16-22	SHEET:	3 OF 4

CURRENT REV.: 1


Well SH-1: THUNDERBALL 1-9-4XHM

SHEET: 8.5x11 SHL: 9-2S-3W

BHL-1: 4-2S-3W



TOTAL PROPOSED DISTURBED AREA: 3.94 ACRES

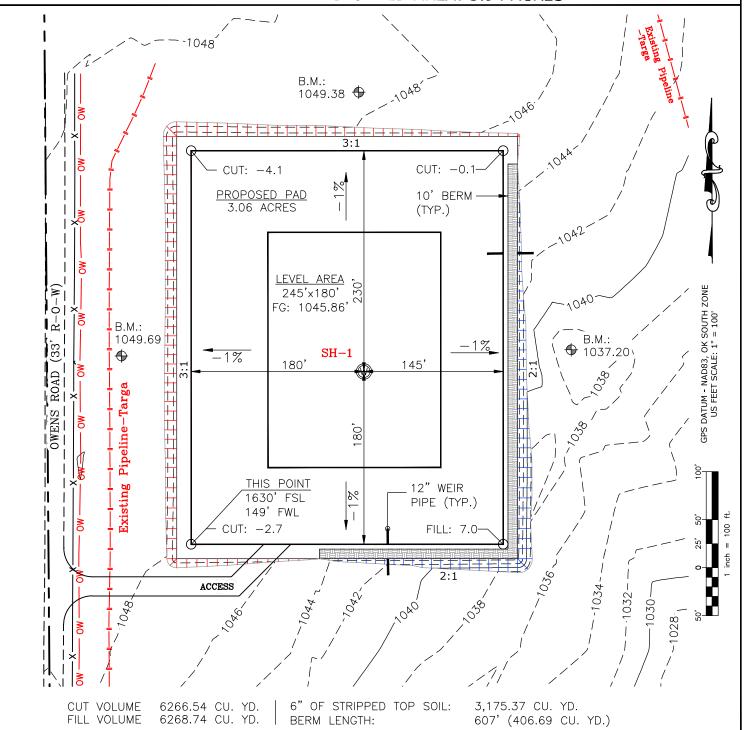

(CUT/FILL VOLUMES DO NOT INCLUDE 6" OF STRIPPED TOP SOIL)

CURRENT REV.: 1

Prepared



PROPOSED GRADING PLAN

DRAWN BY:	HDG	SCALE:	1" = 100'
CHECKED BY:	MJL	JOB No.:	
APPROVED BY:		DWG. NO.:	PRO-GR.
DATE ISSUED:	05-16-22	SHEET:	4 OF 4

EXHIBIT "A"


TABLE OF QUANTITIES

DISTURBED AREA = 3.94 ACRES ACCESS ROAD = ±245'

LOCATED ON THE LANDS OF: DENNIS A. CAMP

PART OF SW/4 SEC 9-2S-3W CARTER COUNTY, OKLAHOMA



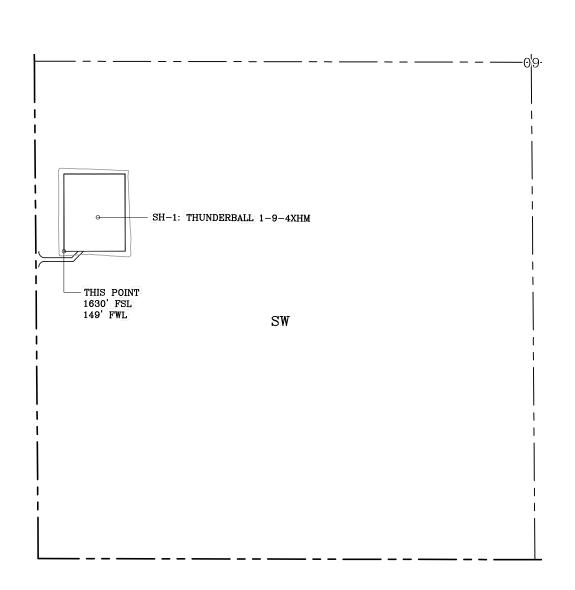

GENERAL NOTES:

- 1. THIS IS NOT A BOUNDARY SURVEY.
- 2. THIS SURVEY DOES NOT GUARANTEE TITLE OR OWNERSHIP.

