API NUMBER: 011 23940

Oil & Gas

Horizontal Hole

#### OKLAHOMA CORPORATION COMMISSION **OIL & GAS CONSERVATION DIVISION** P.O. BOX 52000 **OKLAHOMA CITY, OK 73152-2000** (Rule 165:10-3-1)

Approval Date: 02/13/2018 08/13/2018 **Expiration Date** 

PERMIT TO DRILL

WELL LOCATION: Sec: 06 Twp: 14N Rge: 12W County: BLAINE

FEET FROM QUARTER: SPOT LOCATION: NW FROM NORTH WEST NW llnw

SECTION LINES: 300 460

Lease Name: SIMBA Well No: 1-6-7XHW Well will be 300 feet from nearest unit or lease boundary.

CONTINENTAL RESOURCES INC Operator Telephone: 4052349020: 4052349 OTC/OCC Number: 3186 0 Name:

CONTINENTAL RESOURCES INC

PO BOX 269000

OKLAHOMA CITY. OK 73126-9000 **RICHARD & CHRISTINE DAVIS** 

8707 GA HWY 17

**BOWERSVILLE** GΑ 30516

Formation(s) (Permit Valid for Listed Formations Only):

Name Depth Name Depth WOODFORD 1 13147 6 2 7 8 3 4 9 5 10 665391 Spacing Orders: Location Exception Orders: Increased Density Orders:

Pending CD Numbers: 201602997 Special Orders:

201602998

Total Depth: 23190 Ground Elevation: 1757 Surface Casing: 1500 Depth to base of Treatable Water-Bearing FM: 250

Under Federal Jurisdiction: No Fresh Water Supply Well Drilled: No Surface Water used to Drill:

Approved Method for disposal of Drilling Fluids: PIT 1 INFORMATION

Type of Pit System: CLOSED Closed System Means Steel Pits

Type of Mud System: WATER BASED

Chlorides Max: 8000 Average: 5000

Is depth to top of ground water greater than 10ft below base of pit? Y

Within 1 mile of municipal water well? N

Wellhead Protection Area?

is located in a Hydrologically Sensitive Area.

Category of Pit: C

Liner not required for Category: C Pit Location is AP/TE DEPOSIT Pit Location Formation: TERRACE D. One time land application -- (REQUIRES PERMIT)

PERMIT NO: 17-33663

H. SEE MEMO

#### PIT 2 INFORMATION

Type of Pit System: CLOSED Closed System Means Steel Pits

Type of Mud System: OIL BASED
Chlorides Max: 300000 Average: 200000

Is depth to top of ground water greater than 10ft below base of pit? Y

Within 1 mile of municipal water well? N
Wellhead Protection Area? N

Pit is located in a Hydrologically Sensitive Area.

Category of Pit: C

Liner not required for Category: C
Pit Location is AP/TE DEPOSIT
Pit Location Formation: TERRACE

#### **HORIZONTAL HOLE 1**

Sec 07 Twp 14N Rge 12W County **BLAINE** Spot Location of End Point: S2 SW S2 SW Feet From: SOUTH 1/4 Section Line: 30 WEST Feet From: 660 1/4 Section Line:

Depth of Deviation: 12315 Radius of Turn: 477

Direction: 178

Total Length: 10126

Measured Total Depth: 23190
True Vertical Depth: 13591
End Point Location from Lease,
Unit, or Property Line: 30

Additional Surface Owner	Address	City, State, Zip
HORACE EARL SCOTT, JR.	76010 EW 1270	LIMA, OK 74884
VALARIE MCMILLIAN	749 TREES	CEDAR HILL, TX 75249
CHARLES COLBERT	702 NE 8TH #65	OKLAHOMA CITY, OK 73104
NORMA LEE SPINKS	6201 BRANIFF DRIVE	OKLAHOMA CITY, OK 73105
REGINALD SCOTT	6113 SE 6TH ST	MIDWEST CITY, OK 73110
PATRICIA BARBER	5309 BROADWAY AVE	SPENCER, OK 73084
DONNA VERA WILLIS	519 N. SPEICE	WATONGA, OK 73772
BILLIE MURIEL CURRY	3916 N RICKEY DRIVE	OKLAHOMA CITY, OK 73111
VICKIE R. SCOTT	36010 EW 1270	LIMA, OK 74884
TERRY & GREGORY COLBERT	3321 NE 13TH ST	OKLAHOMA CITY, OK 73117
BRENDA ALLEN	3204 NE 20TH ST	OKLAHOMA CITY, OK 73121
SHIRLENE GREENE	2912 NE 17TH ST.	OKLAHOMA CITY, OK 73111
CLAUDETTE COLBERT	2217 WARRIOR CIRCLE	OKLAHOMA CITY, OK 73121
RONALD DEAN SCOTT	1434 EMMA DRIVE	MIDWEST CITY, OK 73130
CYNTHIA CAROLYN WOODS	1205 LAUREN LANE	OKLAHOMA CITY, OK 73110
WILLARD EARL DAVIS	12001 NE 63RD ST	CHOCTAW, OK 73020
REGINA JOHNSON	10100 NAPA VALLEY DRIVE	FRISCO, TX 75035

Notes:

Category Description

DEEP SURFACE CASING

1/8/2018 - G71 - APPROVED; NOTIFY OCC FIELD INSPECTOR IMMEDIATELY OF ANY LOSS OF CIRCULATION OR FAILURE TO CIRCULATE CEMENT TO SURFACE ON ANY CONDUCTOR OR SURFACE CASING

Category Description

HYDRAULIC FRACTURING 1/8/2018 - G71 - OCC 165:10-3-10 REQUIRES:

1) PRIOR TO COMMENCEMENT OF HYDRAULIC FRACTURING OPERATIONS FOR HORIZONTAL WELLS, NOTICE GIVEN FIVE BUSINESS DAYS IN ADVANCE TO OFFSET OPERATORS WITH WELLS COMPLETED IN THE SAME COMMON SOURCE OF SUPPLY WITHIN 1/2 MILE:

2) WITH NOTICE ALSO GIVEN 48 HOURS IN ADVANCE OF HYDRAULIC FRACTURING ALL WELLS TO BOTH THE OCC CENTRAL OFFICE AND LOCAL DISTRICT OFFICES, USING THE

"FRAC NOTICE FORM" FOUND AT THE FOLLOWING LINK:

OCCEWEB.COM/OG/OGFORMS.HTML; AND,

3) THE CHEMICAL DISCLOSURE OF HYDRAULIC FRACTURING INGREDIENTS FOR ALL WELLS TO BE REPORTED TO FRACFOCUS WITHIN 60 DAYS AFTER THE CONCLUSION THE HYDRAULIC FRACTURING OPERATIONS, USING THE FOLLOWING LINK: FRACFOCUS.ORG

INTERMEDIATE CASING 1/8/2018 - G71 - DUE TO THE KNOWN POTENTIAL RISK OF ENCOUNTERING AN OVER-

PRESSURED ZONE IN THE MORROW SERIES IN THIS AREA, THE TECHNICAL MANAGER RECOMMENDS SETTING AN INTERMEDIATE STRING OF CASING IMMEDIATELY ABOVE THE

MORROW SERIES

MEMO 1/8/2018 - G71 - PITS 1 & 2 - CLOSED SYSTEM=STEEL PITS PER OPERATOR REQUEST, PIT 2 -

OBM RETURNED TO VENDOR, CUTTINGS PERMITTED PER DISTRICT

PENDING CD - 201602997 1/9/2018 - G58 - (I.O.) 6 & 7-14N-12W

EST MULTIUNIT HORIZONTAL WELL

X665391 WDFD 50% 6-14N-12W 50% 7-14N-12W

CONTINENTAL RESOURCES, INC.

REC 2/13/2018 (MURER)

PENDING CD - 201602998 1/9/2018 - G58 - (I.O.) 6 & 7-14N-12W

X665391 WDFD

COMPL. INT. (6-14N-12W) NCT 150' FNL, NCT 0' FSL, NCT 330' FWL COMPL. IN.T (7-14N-12W) NCT 0' FNL, NCT 150' FSL, NCT 330' FWL

CONTINENTAL RESOURCES, INC.

REC 2/13/2018 (MURER)

SPACING - 665391 1/9/2018 - G58 - (640) 6 & 7-14N-12W

EXT 652297 WDFD

**EXHIBIT**: <u>A (1 of 3)</u> SHEET: 8.5×14 06-14N-12W SHL: 07-14N-12W BHL:



## COVER SHEET

# $\frac{\text{CONTINENTAL} \quad \text{RESOURCES,} \quad \text{INC.}}{\text{P.O. BOX 26900 OKLAHOMA CITY, OK 73126 * (T) 1-800-256-8955 (F) 405-234-9253}}$

Section _	06 Township14N	Range12W I.M.	Well 1:	SIMBA 2-6-7XHM	011-23923
County _	BLAINE	State OK	Well 2:	SIMBA 1-6-7XHW	011-23940
Operator	CONTINENTAL RESC	DURCES, INC.	Well 3:		

		NAD-	-83					
POINT	WELL NAME	NORTHING	EASTING	LATITUDE LONGITUDE	LATITUDE LONGITUDE		EXISTING ELEVATION	DESIGN ELEVATION
W1	SIMBA 2-6-7XHM	264093	1812917	35* 43' 27.62" -98* 31' 26.94"	35.724340 -98.524149	300' FNL / 430' FWL (NW/4 SEC 06)	1757.89	1756.79
W2	SIMBA 1-6-7XHW	264093	1812947	35° 43′ 27.63″ -98° 31′ 26.57″	35.724341 -98.524048	300' FNL / 460' FWL (NW/4 SEC 06)	1757.87	1756.79
LP-1	LANDING POINT	264000	1812817	35* 43' 26.70" -98* 31' 28.15"	35.724084 -98.524487	393' FNL / 330' FWL (NW/4 SEC 06)		
LP-2	LANDING POINT	264000	1813147	35° 43′ 26.72″ -98° 31′ 24.15″	35.724089 -98.523375	392' FNL / 660' FWL (NW/4 SEC 06)		
BHL-1	BOTTOM HOLE LOCATION	253875	1812743	35* 41' 46.57" -98* 31' 28.38"	35.696269 -98.524550	30' FSL / 330' FWL (SW/4 SEC 07)		
BHL-2	BOTTOM HOLE LOCATION	253874	1813073	35° 41' 46.58" -98° 31' 24.38"	35.696272 -98.523439	30' FSL / 660' FWL (SW/4 SEC 07)		
X-1	MARTIN #1-7	254506	1813138	35* 41' 52.83" -98* 31' 23.63"	35.698008 -98.523231	7-14N-12W:CSW4SW4   TD: 11,375'   660' FSL - 722' FWL		
X-2	NITZEL #1-7	255820	1816286	35° 42' 05.99" -98° 30' 45.55"	35.701664 -98.512654	7-14N-12W:CN2SE4   TD: 11,400'   1,980' FSL - 1,320' FEL		
X-3	BORDEN LAND CO. #1-7	257597	1813906	35° 42' 23.43" -98° 31' 14.52"	35.706510 -98.520700	7-14N-12W:NW4NW4SE4NW4   TD: 11,350'   1,520' FNL - 1,470' FWL		
X-4	MCCLUNG #1	263074	1813798	35° 43' 17.60" -98° 31' 16.19"	35.721556 -98.521163	6-14N-12W:CNW4   TD: 11,300'   1,320' FSL - 1,320' FWL		

		NAD-	-27					
POINT	WELL NAME	NORTHING	EASTING	LATITUDE LONGITUDE	LATITUDE LONGITUDE		EXISTING ELEVATION	DESIGN ELEVATION
W1	SIMBA 2-6-7XHM	264068	1844518	35° 43′ 27.45″ -98° 31′ 25.67″	35.724293 -98.523797	300' FNL / 430' FWL (NW/4 SEC 06)	1757.89	1756.79
W2	SIMBA 1-6-7XHW	264068	1844548	35° 43′ 27.46″ -98° 31′ 25.30″	35.724293 -98.523696	300' FNL / 460' FWL (NW/4 SEC 06)	1757.87	1756.79
LP-1	LANDING POINT	263975	1844417	35° 43' 26.53" -98° 31' 26.88"	35.724037 -98.524135	393' FNL / 330' FWL (NW/4 SEC 06)		
LP-2	LANDING POINT	263975	1844747	35° 43′ 26.55″ -98° 31′ 22.88″	35.724042 -98.523023	392' FNL / 660' FWL (NW/4 SEC 06)		
BHL-1	BOTTOM HOLE LOCATION	253850	1844343	35° 41′ 46.39" -98° 31′ 27.12"	35.696221 -98.524199	30' FSL / 330' FWL (SW/4 SEC 07)		
BHL-2	BOTTOM HOLE LOCATION	253850	1844673	35° 41′ 46.41″ -98° 31′ 23.12″	35.696224 -98.523088	30' FSL / 660' FWL (SW/4 SEC 07)		
X-1	MARTIN #1-7	254481	1844738	35° 41' 52.66" -98° 31' 22.37"	35.697961 -98.522880	7-14N-12W:CSW4SW4   TD: 11,375'   660' FSL - 722' FWL		
X-2	NITZEL #1-7	255795	1847886	35° 42′ 05.82″ -98° 30′ 44.29″	35.701616 -98.512303	7-14N-12W:CN2SE4   TD: 11,400'   1,980' FSL - 1,320' FEL		
X-3	BORDEN LAND CO. #1-7	257572	1845507	35° 42' 23.26" -98° 31' 13.26"	35.706462 -98.520349	7-14N-12W:NW4NW4SE4NW4   TD: 11,350'   1,520' FNL - 1,470' FWL		
X-4	MCCLUNG #1	263049	1845399	35° 43′ 17.43″ -98° 31′ 14.92″	35.721508 -98.520811	6-14N-12W:CNW4   TD: 11,300'   1,320' FSL - 1,320' FWL		

Certificate of Authorization No. 7318

Date Staked: 12-21-17 Date Drawn: 12-20-17



Prepared By:
Petro Land Services South
10404 Vineyard Blvd.
Suite G100
Oklahoma City, OK 73120

R E	REVISIONS							
No.	DATE	BY	DESCRIPTION	COMMENTS				
00	12-20-17	MJL	ISSUED FOR APPROVAL					
01	12-21-17	MJL	CORRECT WELL NAMES	ALL SHEETS				
02	12-21-17	MJL	CORRECT WELL NAMES	ALL SHEETS				


# PETRO LAND SERVICES SOUTH, LLC 10404 VINEYARD BLVD. SUITE G100, OKLA. CITY, OKLA. 73120 \* OFFICE (405) 212-3108





CONTINENTAL RESOURCES, INC (OPERATOR)

WELL 1: SIMBA 2-6-7XHM

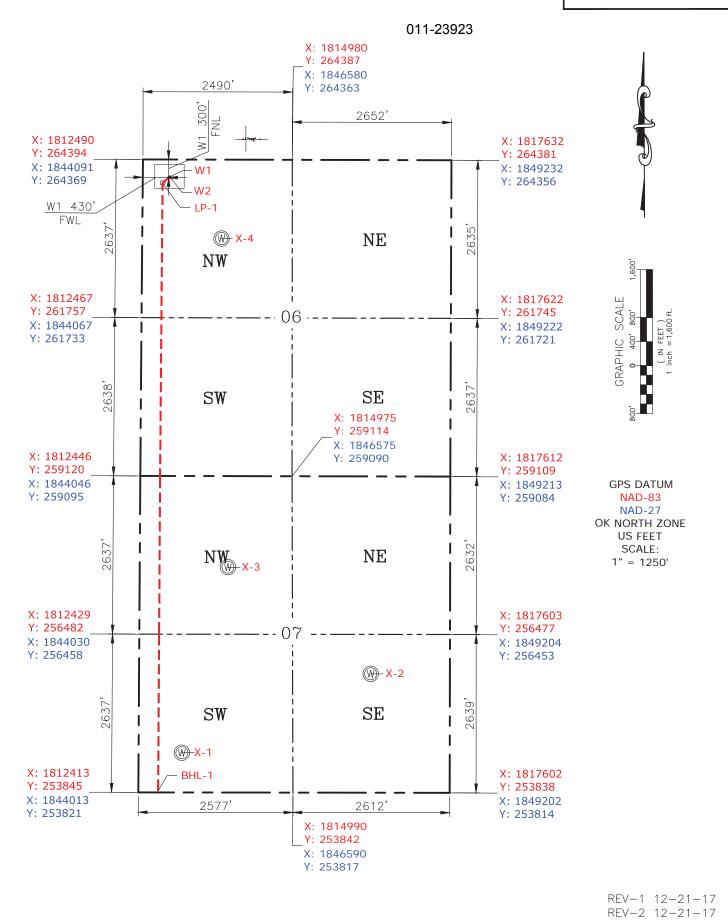

Please note that this location was staked on the ground under the supervision of a Licensed Professional Land Surveyor, but the accuracy of this survey is not guaranteed. Please contact PLS promptly if any inconsistency is determined. GPS data is observed from RTK-GPS. NOTE: X and Y data shown hereon for Section Corners may NOT have been surveyed on-the-ground, and further, does NOT represent a true Boundary Survey. Quarter Section distances may be assumed from a Government Survey Plat or assumed at a proportionate distance from opposing section corners, or occupation thereof, and may not have been measured on-the-ground, and further, does not represent a true Boundary Survey.

### **CERTIFICATE:**

**EXHIBIT**: <u>A (2 of 3)</u>

SHEET:

SHI:

BHL:

8.5x14

06 - 14N - 12W

07-14N-12W

I, Beau Winfrey an Oklahoma Licensed Land Surveyor and an authorized agent of Petro Land Services South, LLC, do hereby certify to the information shown herein.



Oklahoma PLS No.1766

Date Staked: 12-21-17 Date Drawn: 12-20-17

# PETRO LAND SERVICES SOUTH, LLC 10404 VINEYARD BLVD. SUITE G100, OKLA. CITY, OKLA. 73120 \* OFFICE (405) 212-3108



CONTINENTAL RESOURCES, INC

8.5x14 SHEET: 06 - 14N - 12WSHI:

BHL:


07-14N-12W

**EXHIBIT**: <u>A (3 of 3)</u>

BLAINE \_ County Oklahoma 300' FNL-460' FWL Section 06 Township 14N Range 12W I.M.

(OPERATOR)


WELL 2: SIMBA 1-6-7XHW

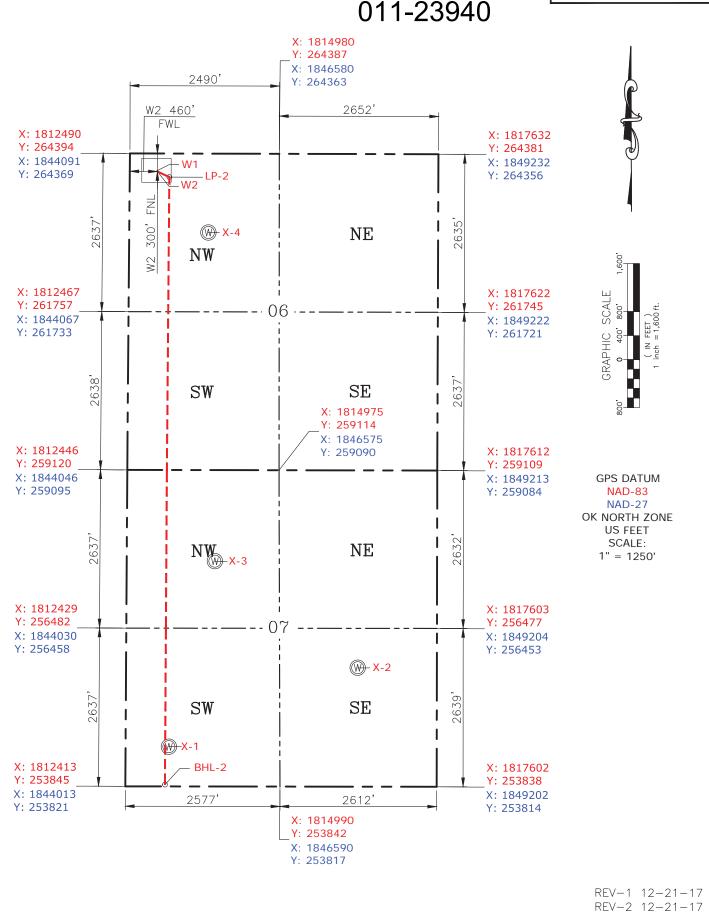

Please note that this location was staked on the ground under the supervision of a Licensed Professional Land Surveyor, but the accuracy of this survey is not guaranteed. Please contact PLS promptly if any inconsistency is determined. GPS data is observed from RTK-GPS. NOTE: X and Y data shown hereon for Section Corners may NOT have been surveyed on-the-ground, and further, does NOT represent a true Boundary Survey. Quarter Section distances may be assumed from a Government Survey Plat or assumed at a proportionate distance from opposing section corners, or occupation thereof, and may not have been measured on-the-ground, and further, does not represent a true Boundary Survey.

### **CERTIFICATE:**

I, Beau Winfrey an Oklahoma Licensed Land Surveyor and an authorized agent of Petro Land Services South, LLC, do hereby certify to the information shown herein.

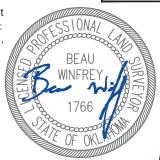

12/21/17

Date Staked: 12-21-17 Date Drawn: 12-20-17

Oklahoma PLS No.1766

DATE

EXHIBIT: \_

SHEET:

SHL:

BHL:

8.5x11

07 - 14N - 12W

PETRO LAND SERVICES SOUTH, LLC

10404 VINEYARD BLVD. SUITE G100, OKLA. CITY, OKLA. 73120 \* OFFICE (405) 212-3108 Certificate of Authorization No. 7318

W1: 300' FNL-430' FWL

**BLAINE** \_ County Oklahoma




CONTINENTAL RESOURCES, INC (OPERATOR)

06-14N-12W W2: 300' FNL-460' FWL

W2:

06\_\_\_ Township Section \_

14N Range 12W I.M.

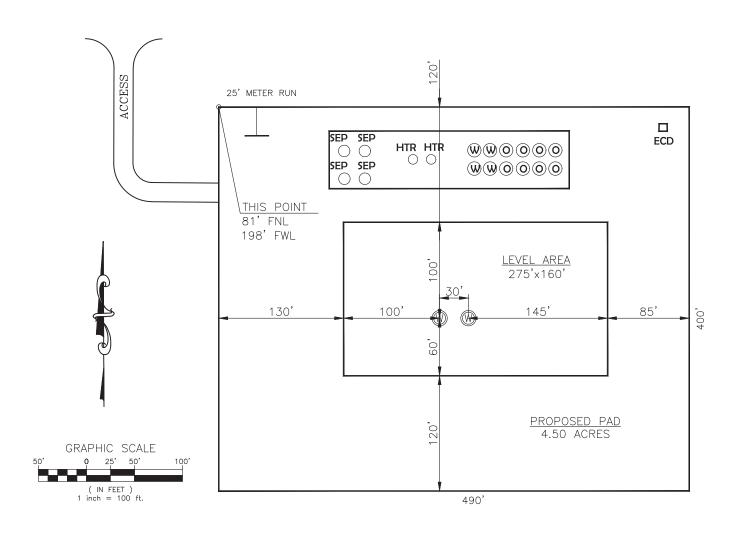

REV-1 12-21-17 REV-2 12-21-17

W1: SIMBA 1-6-7XHW W2: SIMBA 1-6-7XHW DATUM: NAD-83 DATUM: NAD-83 35°43'27.62" 35°43'27.63" LAT: LAT: <u>-98°31'26.94"</u> LONG: LONG:

<u>-98°31'26.57"</u> 35.724340° LAT: 35.724341°

STATE PLANE

COORDINATES

<u>-98.524149°</u> <u>-98.524048°</u> LONG: LONG:

STATE PLANE COORDINATES (US FEET): OK NORTH

LAT:

(US FEET): OK NORTH <u>1814301</u> <u> 1814331</u> X:

X: 264722 264722 Y: Υ:

Operator: CONTINENTAL RESOURCES, INC.

Lease Name: \_\_\_ Topography & Vegetation: Pasture Good Drill Site? Yes

Reference Stakes or Alternate Location Stakes Set: No

Best Accessibility to Location: From The North Line

Distance & Direction From Hwy. or Town: Starting from the Intersection of SH-8 & E-0885 Road. Head west to N-2570 and turn left. Travel south for 0.5 miles & turn right onto E-0890 Rd. Head west on E-0890 Rd. for 5.95 miles to the proposed access along the south side of road.

THE INFORMATION SHOWN HEREIN IS FOR CONSTRUCTION **PURPOSES ONLY** 

SIMBA 2-6-7XHM Well W1: \_ SIMBA 1-6-7XHWWell W2: \_ Well W3: -

This Information Was Gathered With a GPS Receiver With ±1 Foot Horiz./Vert. Accuracy

LANDING POINT, BOTTOM HOLE AND DRILL PATH INFORMATION PROVIDED BY OPERATOR LISTED NOT SURVEYED.



Prepared By: Petro Land Services South 10404 Vineyard Blvd. Suite G100 Oklahoma City, OK 73120

Certificate of Authorization No. 7318


EXHIBIT: C SHEET: 8.5x11 06-14N-12W

SHL: 06-14N-12WBHL: 07-14N-12W



## VICINITY MAP

SCALE: N.T.S

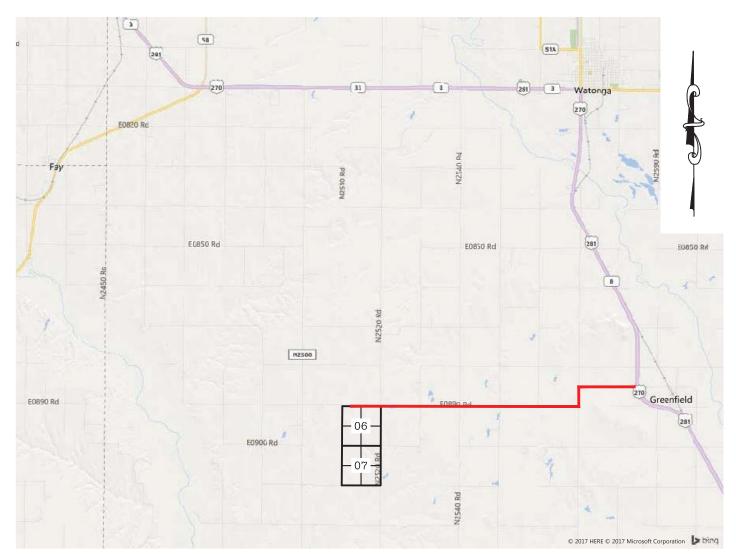

STARTING FROM THE INTERSECTION OF SH-8 & E-0885 ROAD. HEAD WEST TO N-2570 AND TURN LEFT. TRAVEL SOUTH FOR 0.5 MILES & TURN RIGHT ONTO E-0890 RD. HEAD WEST ON E-0890 RD. FOR 5.95 MILES TO THE PROPOSED ACCESS ALONG THE SOUTH SIDE OF ROAD.

### CONTINENTAL RESOURCES, INC.

P.O. BOX 26900 OKLAHOMA CITY, OK 73126 \* (T) 1-800-256-8955 (F) 405-234-9253

Certificate of Authorization No. 7318	Section06	Township _	14NRange	12W_I.M.	Well W1:_	SIMBA 2-6-7XHM
Date Staked: 12-21-17	County	BLAINE	State _	OK	Well W2:_	SIMBA 1-6-7XHW
Prepared Ry	Operator	CONTINENTA	L RESOURCES,	INC.		



Prepared By:
Petro Land Services South
10404 Vineyard Blvd.
Suite G100
Oklahoma City, OK 73120

REV-1 12-21-17 REV-2 12-21-17 EXHIBIT: \_\_\_\_

SHEET: 8.5x11

SHL: 06-14N-12WBHL: 07-14N-12W



WELL 1: SIMBA 2-6-7XHM

WELL 2: SIMBA 1-6-7XHW

FACING NORTH

(PHOTO UNAVAILABLE)

FACING SOUTH

(PHOTO UNAVAILABLE)

REV-1 12-21-17 REV-2 12-21-17



TERRAIN

DRAWN BY:	MJL	SCALE:	N.T.S.
CHECKED BY:	MVA	JOB No.:	
APPROVED BY:		DWG. NO.:	TERRAIN-1
DATE ISSUED:	12-20-17	SHEET:	1 OF 2

EXHIBIT: \_\_\_E

SHEET: 8.5x11

SHL:  $\frac{06-14N-12W}{07-14N-12W}$ 



WELL 1: SIMBA 2-6-7XHM

WELL 2: SIMBA 1-6-7XHW

FACING EAST

(PHOTO UNAVAILABLE)

FACING WEST

(PHOTO UNAVAILABLE)

REV-1 12-21-17 REV-2 12-21-17



Τ	Ε	R	R	Α	Ι	N
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DRAWN BY:	MJL	SCALE:	N.T.S.
CHECKED BY:	MVA	JOB No.:	
APPROVED BY:		DWG. NO.:	TERRAIN-2
DATE ISSUED:	12-20-17	SHEET:	2 OF 2

EXHIBIT: \_\_\_\_F

SHEET: 8.5x11

06-14N-12W SHL: BHL: <u>07-14N-12</u>W




WELL 1: SIMBA 2-6-7XHM

WELL 2: SIMBA 1-6-7XHW

### PROPOSED ACCESS ROAD = 246' | 14.91 RODS (TOTAL)

THIS POINT 81' FNL 198' FWL

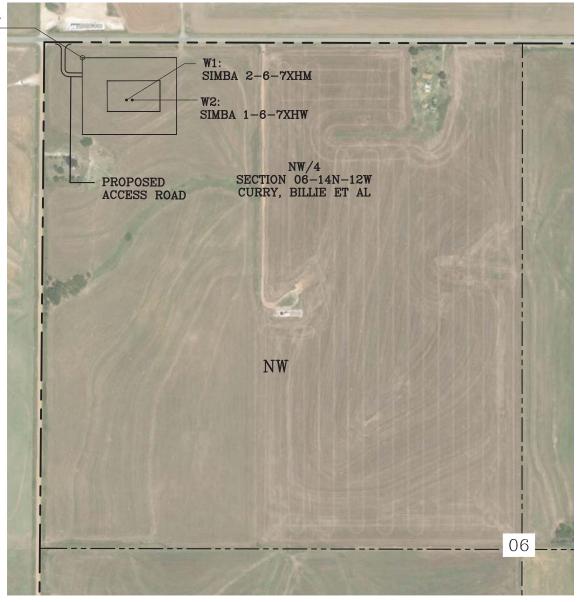


GPS DATUM - OK NORTH ZONE US FEET SCALE: 1" = 500'

Section \_\_\_\_06\_ Township \_\_\_14N\_ Range \_\_\_12W\_ I.M.

County BLAINE State OK

Operator CONTINENTAL RESOURCES, INC.

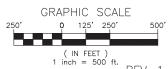


REV-1 12-21-17 REV-2 12-21-17



Prepared By: Petro Land Services South 10404 Vineyard Blvd. Suite G100 Oklahoma City, OK 73120

AERIAL PLAT

DRAWN BY:	MJL	SCALE:	1" = 500'
CHECKED BY:	MVA	JOB No.:	
APPROVED BY:		DWG. NO.:	AERIAL-1
DATE ISSUED:	12-20-17	SHFFT:	1 OF 4

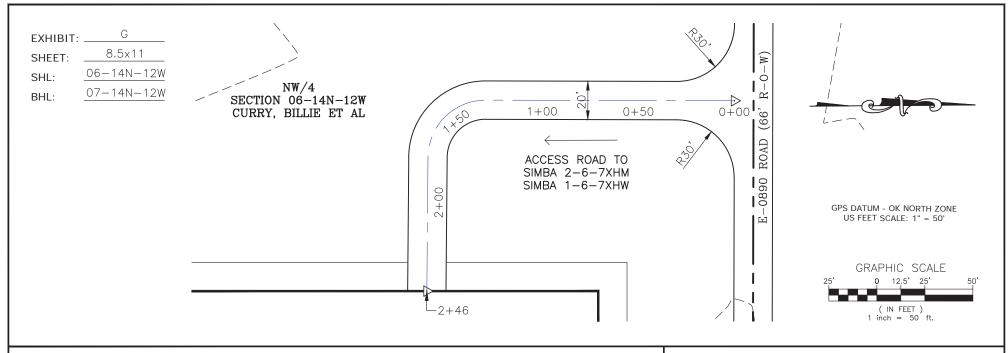


THIS PROPOSED LEASE ROAD PLAT DOES NOT REPRESENT A TRUE BOUNDARY SURVEY.


THE FOOTAGES AND TIES SHOWN HEREON ARE FROM LINES OF OCCUPATION AND MAY NOT BE FROM ACTUAL PROPERTY CORNERS.

WELL 1: SIMBA 2-6-7XHM

WELL 2: SIMBA 1-6-7XHW

PROPOSED ACCESS ROAD = 246' | 14.91 RODS (TOTAL)

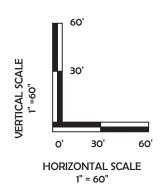

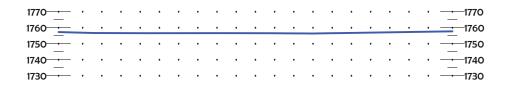

REV-1 12-21-17 REV-2 12-21-17

PLS

Prepared By: Petro Land Services South 10404 Vineyard Blvd. Suite G100 Oklahoma City, OK 73120



P.O Box 26900 Oklahoma City Oklahoma, 73126 (T) 1-800-256-8955 (F) 405-234-9253 LEASE ROAD PLAN & PROFILE

DRAWN BY:	MJL	SCALE:	AS NOTED
CHECKED BY:	MVA	JOB No.:	
APPROVED BY:		DWG. NO.:	P&P
DATE ISSUED:	12-20-17	SHEET:	2 OF 4

EXHIBIT: H


SHEET: 8.5x11

SHL: 06-14N-12WBHL: 07-14N-12W



WELL 1: SIMBA 2-6-7XHM

WELL 2: SIMBA 1-6-7XHW

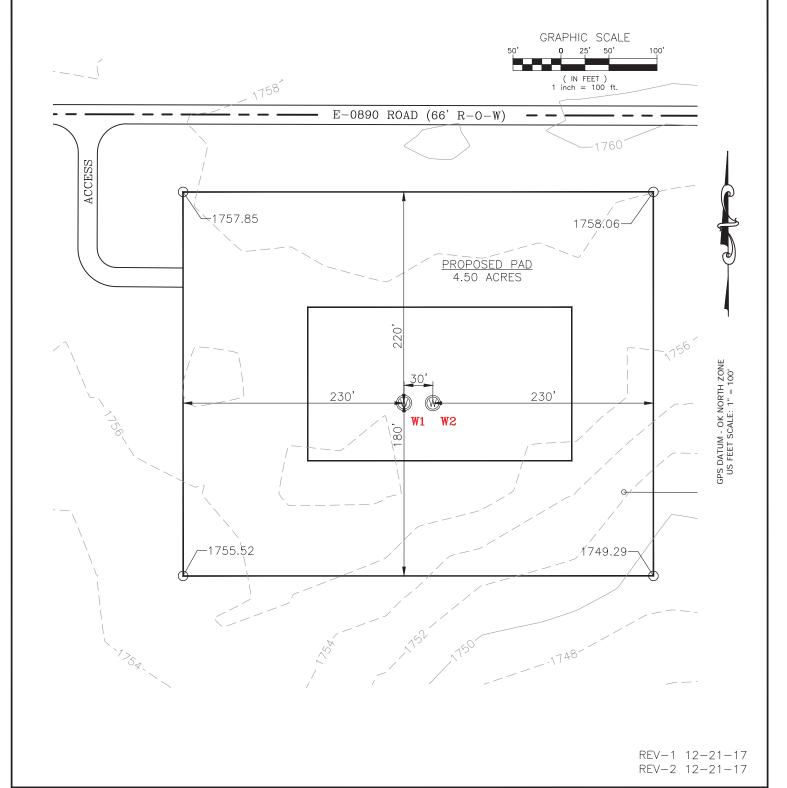

PLS

Prepared By: Petro Land Services South 10404 Vineyard Blvd. Suite G100 Oklahoma City, OK 73120 EXISTING GRADING PLAN

DRAWN BY:	MJL	SCALE:	1" = 100'
CHECKED BY:	MVA	JOB No.:	
APPROVED BY:		DWG. NO.:	EX-GR.
DATE ISSUED:	12-20-17	SHEET:	3 OF 4

EXHIBIT: \_\_\_\_\_\_ | 8.5x11


SHL: 06-14N-12WBHL: 07-14N-12W



WELL 1: SIMBA 2-6-7XHM

WELL 2: SIMBA 1-6-7XHW

### TOTAL PROPOSED DISTURBED AREA: 5.50 ACRES

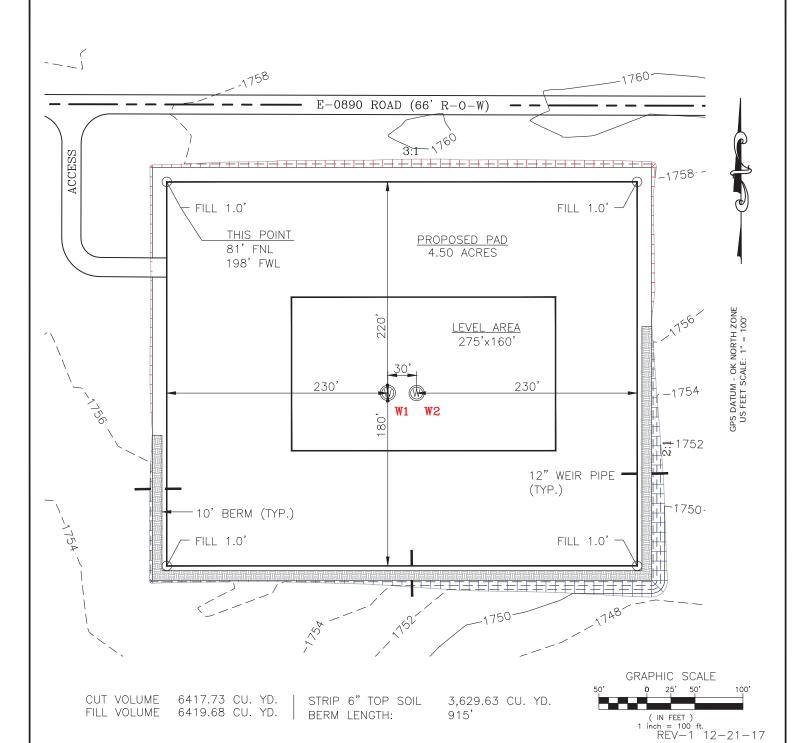

PLS

Prepared By: Petro Land Services South 10404 Vineyard Blvd. Suite G100 Oklahoma City, OK 73120 PROPOSED GRADING PLAN

		REV-2	12-21-17
DRAWN BY:	MJL	SCALE:	1" = 100'
CHECKED BY:	MVA	JOB No.:	
APPROVED BY:		DWG. NO.:	PRO-GR.
DATE ISSUED:	12-20-17	SHEET:	4 OF 4