API NUMBER: 011 23970

Oil & Gas

Horizontal Hole

#### OKLAHOMA CORPORATION COMMISSION OIL & GAS CONSERVATION DIVISION P.O. BOX 52000 OKLAHOMA CITY, OK 73152-2000 (Rule 165:10-3-1)

Approval Date: 03/27/2018

Expiration Date: 09/27/2018

PERMIT TO DRILL

WELL LOCATION: Sec: 24 Twp: 15N Rge: 11W County: BLAINE

SPOT LOCATION: NW SW SW SE FEET FROM QUARTER: FROM SOUTH FROM EAST SECTION LINES: 335 2420

Lease Name: JALOU Well No: 1-25-36XHM Well will be 335 feet from nearest unit or lease boundary.

Operator CONTINENTAL RESOURCES INC. Telephone: 4052349020; 4052349 OTC/OCC Number: 3186 0

CONTINENTAL RESOURCES INC.

PO BOX 269000

OKLAHOMA CITY, OK 73126-9000

HARLAN G. TOMLINSON

RT 2 BOX 119

WATONGA OK 73772

Formation(s) (Permit Valid for Listed Formations Only):

Name Depth Name Depth MISSISSIPPIAN 1 10325 6 2 WOODFORD 11755 7 3 8 4 9 5 10 657035 Spacing Orders: Location Exception Orders: Increased Density Orders: 669154 586354 651181

Pending CD Numbers: 201801498 Special Orders:

201801499 201801490

Total Depth: 21390 Ground Elevation: 1443 Surface Casing: 1500 Depth to base of Treatable Water-Bearing FM: 130

Under Federal Jurisdiction: No Fresh Water Supply Well Drilled: No Surface Water used to Drill: No

PIT 1 INFORMATION Approved Method for disposal of Drilling Fluids:

Type of Pit System: CLOSED Closed System Means Steel Pits

Type of Mud System: WATER BASED

Chlorides Max: 8000 Average: 5000

Is depth to top of ground water greater than 10ft below base of pit? Y

Within 1 mile of municipal water well? N

Wellhead Protection Area? N

Pit is located in a Hydrologically Sensitive Area.

Category of Pit: C

Liner not required for Category: C

Pit Location is ALLUVIAL

Pit Location Formation: ALLUVIUM

D. One time land application -- (REQUIRES PERMIT) PERMIT NO: 18-34086

H. SEE MEMO

#### PIT 2 INFORMATION

Type of Pit System: CLOSED Closed System Means Steel Pits

Type of Mud System: OIL BASED
Chlorides Max: 300000 Average: 200000

Is depth to top of ground water greater than 10ft below base of pit? Y

Within 1 mile of municipal water well? N

Wellhead Protection Area? N

Pit is located in a Hydrologically Sensitive Area.

Category of Pit: C

Liner not required for Category: C

Pit Location is ALLUVIAL

Pit Location Formation: ALLUVIUM

#### **HORIZONTAL HOLE 1**

Sec 36 Twp 15N Rge 11W County BLAINE

Spot Location of End Point: SW SW SW SE

Feet From: SOUTH 1/4 Section Line: 50

Feet From: EAST 1/4 Section Line: 2475

Depth of Deviation: 10177 Radius of Turn: 477

Direction: 181

Total Length: 10463

Measured Total Depth: 21390
True Vertical Depth: 11843
End Point Location from Lease,
Unit, or Property Line: 50

Notes:

Category Description

DEEP SURFACE CASING 3/13/2018 - G71 - APPROVED; NOTIFY OCC FIELD INSPECTOR IMMEDIATELY OF ANY LOSS OF

CIRCULATION OR FAILURE TO CIRCULATE CEMENT TO SURFACE ON ANY CONDUCTOR OR

SURFACE CASING

HYDRAULIC FRACTURING 3/13/2018 - G71 - OCC 165:10-3-10 REQUIRES:

1) PRIOR TO COMMENCEMENT OF HYDRAULIC FRACTURING OPERATIONS FOR HORIZONTAL WELLS, NOTICE GIVEN FIVE BUSINESS DAYS IN ADVANCE TO OFFSET OPERATORS WITH WELLS COMPLETED IN THE SAME COMMON SOURCE OF SUPPLY WITHIN 1/2 MILE:

2) WITH NOTICE ALSO GIVEN 48 HOURS IN ADVANCE OF HYDRAULIC FRACTURING ALL WELLS TO BOTH THE OCC CENTRAL OFFICE AND LOCAL DISTRICT OFFICES, USING THE

"FRAC NOTICE FORM" FOUND AT THE FOLLOWING LINK:

OCCEWEB.COM/OG/OGFORMS.HTML; AND,

3) THE CHEMICAL DISCLOSURE OF HYDRAULIC FRACTURING INGREDIENTS FOR ALL WELLS

TO BE REPORTED TO FRACFOCUS WITHIN 60 DAYS AFTER THE CONCLUSION THE HYDRAULIC FRACTURING OPERATIONS, USING THE FOLLOWING LINK: FRACFOCUS.ORG

INCREASED DENSITY - 669154 3/21/2018 - G58 - 36-15N-11W

X586354 MSSP 10 WELLS NO OP. NAMED 10/18/2017

INTERMEDIATE CASING 3/13/2018 - G71 - DUE TO THE KNOWN POTENTIAL RISK OF ENCOUNTERING AN OVER-

PRESSURED ZONE IN THE MORROW SERIES IN THIS AREA, THE TECHNICAL MANAGER RECOMMENDS SETTING AN INTERMEDIATE STRING OF CASING IMMEDIATELY ABOVE THE

**MORROW SERIES** 

Category Description

MEMO 3/13/2018 - G71 - PITS 1 & 2 - CLOSED SYSTEM=STEEL PITS PER OPERATOR REQUEST. PIT 2 -

OBM RETURNED TO VENDOR, CUTTINGS PERMITTED PER DISTRICT

PENDING CD - 201801490 3/21/2018 - G58 - 25-15N-11W

X657035 MSSP 5 WELLS NO OP. NAMED

REC 3/27/2018 (MINMIER)

PENDING CD – 201801498 3/21/2018 - G58 - (I.O.) 25 & 36-15N-11W

EST MULTIUNIT HORIZONTAL WELL X657035 MSSP (25-15N-11W) X651181 WDFD (25-15N-11W) X586354 MSSP, WDFD (36-15N-11W)

(WDFD ADJACENT COMMON SOURCE OF SUPPLY TO MSSP) \*\*

50% 25-15N-11W 50% 36-15N-11W NO OP. NAMED

REC 3/27/2018 (MINMIER)

\*\*NOT SPECIFIED IN APPLICATION TO BE CORRECTED AT HEARING PER ATTORNEY FOR OP.

PENDING CD – 201801499 3/21/2018 - G58 - (I.O.) 25 & 36-15N-11W

X657035 MSSP (25-15N-11W) X651181 WDFD (25-15N-11W) X586354 MSSP, WDFD (36-15N-11W)

X165:10-3-28(C)(2)(B) MAY BE CLOSER THAN 600' TO EXISTING/PROPOSED WELL

COMPL. INT. (25-15N-11W) NCT 150' FNL, NCT 0' FSL, NCT 1320' FWL COMPL. INT. (36-15N-11W) NCT 0' FNL, NCT 150' FSL, NCT 1320' FWL

NO OP. NAMED

REC 3/27/2018 (MINMIER)

SPACING - 586354 3/21/2018 - G58 - (640)/(640)(HOR) 36-15N-11W

**EXT OTHERS** 

EXT (640) 569413 MSSP EST (640)(HOR) WDFD

COMPL. ÍNT. (WDFD) NLT 165' FNL & FSL, NLT 330' FEL & FWL

SPACING – 651181 3/21/2018 - G58 - (640)(HOR) 25-15N-11W

EST MSSSD (VAC BY 657035), WDFD, OTHER

COMPL. INT. (MSSSD) NLT 660' FB

COMPL. INT. (WDFD) NLT 165' FNL & FSL, NLT 330' FEL & FWL

SPACING - 657035 3/21/2018 - G58 - (640)(HOR) 25-15N-11W

VAC 651181 MSSSD

**EST MSSP** 

COMPL. INT. (MSSP) NCT 660' FB

EXHIBIT: A (1 of 4)

SHEET: 8.5x11

24-15N-11W

SHL:  $\frac{24-15N-11W}{36-15N-11W}$ 



# COVER SHEET

### CONTINENTAL RESOURCES, INC.

P.O. BOX 26900 OKLAHOMA CITY, OK 73126 \* (T) 1-800-256-8955 (F) 405-234-9253

Section 24 Township 15N Range 11W I.M. Well: JALOU 1-25-36XHM 011-23970

Operator \_\_\_\_\_CONTINENTAL RESOURCES, INC.

		NAD-	-83					
POINT	WELL NAME	NORTHING	EASTING	LATITUDE LONGITUDE	LATITUDE LONGITUDE		EXISTING ELEVATION	DESIGN ELEVATION
W1	JALOU 1-25-36XHM	274994	1873152	35° 45' 18.03" -98° 19' 16.84"	35.755008 -98.321345	335' FSL / 2,420' FEL (SE/4 SEC 24)	1443.07	1444.57
LP-1	LANDING POINT	274628	1872752	35° 45′ 14.40″ -98° 19′ 21.68″	35.754001 -98.322688	30' FNL / 2,475' FWL (NW/4 SEC 25)		
BHL-1	BOTTOM HOLE LOCATION	264165	1872730	35° 43′ 30.92″ -98° 19′ 21.53″	35.725255 -98.322647	50' FSL / 2,475' FWL (SW/4 SEC 36)		
W2	JALOU 2-25-36XHM	274964	1873152	35° 45' 17.73" -98° 19' 16.84"	35.754926 -98.321345	305' FSL / 2,420' FEL (SE/4 SEC 24)	1442.94	1444.57
LP-2	LANDING POINT	274629	1873589	35° 45′ 14.43″ -98° 19′ 11.52″	35.754009 -98.319867	30' FNL / 1,980' FEL (NE/4 SEC 24)		
BHL-2	BOTTOM HOLE LOCATION	264165	1873550	35° 43′ 30.95″ -98° 19′ 11.58″	35.725263 -98.319883	50' FSL / 1,980' FEL (SE/4 SEC 36)		-
X-1	WALKER #1-24	275322	1870940	35° 45′ 21.20″ -98° 19′ 43.69″	35.755888 -98.328804	24-15N-11W:SW4SW4   TD: 10,100'   660' FSL / 660' FWL		
X-2	LYLE CARTER #1	270707	1874235	35° 44' 35.67" -98° 19' 03.53"	35.743242 -98.317647	25-15N-11W:SE4   TD: 10,170'   1,320' FSL / 1,320' FWL		
X-3	GIGER #1-25	270704	1871599	35° 44′ 35.55″ -98° 19′ 35.50″	35.743209 -98.326529	25-15N-11W:SW4   TD: 10,180'   1,320' FSL / 1,320' FWL		
X-4	LAIRD #1-25	272686	1875071	35° 44' 55.26" -98° 18' 53.47"	35.748685 -98.314852	25-15N-11W:W2E2SE4NW4   TD: 10,200'   660' FSL / 2,145' FWL		
X-5	HELM TRUST #1-25	273166	1874909	35° 45′ 00.01" -98° 18′ 55.46"	35.750003 -98.315405	25-15N-11W:N2N2SE4NE4   TD: 10,100'   1,140' FSL / 1,980' FWL		
X-6	H.F. LOOKABOUGH #1	265437	1871584	35° 43' 43.46" -98° 19' 35.48"	35.728740 -98.326521	36-15N-11W:SW4   TD: 10,300'   1,320' FSL / 1,320' FWL		
X-7	H.F. LOOKABOUGH #2	265435	1872895	35° 43′ 43.48″ -98° 19′ 19.57″	35.728745 -98.322103	36-15N-11W:S2   TD: 10,250'   1,320' FSL / 2,640' FWL		
X-8	E. LEWIS #1	268067	1874224	35° 44' 09.56" -98° 19' 03.56"	35.735989 -98.317656	36-15N-11W:NE4   TD: 10,178'   1,320' FSL / 1,320' FWL		
X-9	LOOKABOUGH #2	268056	1871597	35° 44' 09.37" -98° 19' 35.43"	35.735935 -98.326508	36-15N-11W:NW4   TD: 10,250'   1,320' FSL / 1,320' FWL		
X-10	LOOKABOUGH #3	265437	1871364	35° 43′ 43.46″ -98° 19′ 38.14″	35.728739 -98.327262	36-15N-11W:E2E2W2SW4   TD: 10,400'   1,320' FSL / 1,100' FWL		
X-11	LEWIS #2-36	267080	1874881	35° 43' 59.82" -98° 18' 55.56"	35.733282 -98.315432	36-15N-11W:S2SE4NE4   TD: 10,130'   330' FSL / 1,980' FWL		
X-12	LOOKABOUGH 25_24-15N-11W	269139	1870514	35* 44' 20.04" -98* 19' 48.61"	35.738899 -98.330170	36-15N-11W:NW4NW4NW4NW4   TD: 21,890'   244' FNL / 234' FWL		-
X-13	MOWERY #1-36H	269134	1871355	35° 44' 20.01" -98° 19' 38.41"	35.738893 -98.327336	36-15N-11W:NE4NE4NW4NW4   TD: 16,259'   250' FNL / 1,075' FWL		

Certificate of Authorization No. 7318

Date Staked: 02-20-18 Date Drawn: 02-20-18



Prepared By: Petro Land Services South 10400 Vineyard Blvd. Suite C Oklahoma City, OK 73120

R E	REVISIONS							
No.	DATE	BY	DESCRIPTION	COMMENTS				
00	02-20-18	MJL	ISSUED FOR APPROVAL					

EXHIBIT: <u>A (2 of 4)</u>
SHEET: <u>8.5x11</u>

SHL:  $\frac{24-15N-11W}{36-15N-11W}$ 



# COVER SHEET

### CONTINENTAL RESOURCES, INC.

P.O. BOX 26900 OKLAHOMA CITY, OK 73126 \* (T) 1-800-256-8955 (F) 405-234-9253

Section  $\underline{\phantom{0}24}$  Township  $\underline{\phantom{0}15N}$  Range  $\underline{\phantom{0}11W}$  I.M. Well:  $\underline{\phantom{0}JALOU\ 1-25-36XHM}$ 

County BLAINE State OK Well: JALOU 2-25-36XHM

Operator \_\_\_\_\_CONTINENTAL RESOURCES, INC.

		NAD-	-27					
POINT	WELL NAME	NORTHING	EASTING	LATITUDE LONGITUDE	LATITUDE LONGITUDE		EXISTING ELEVATION	DESIGN ELEVATION
W1	JALOU 1-25-36XHM	274970	1904752	35° 45′ 17.87" -98° 19′ 15.60"	35.754963 -98.321001	335' FSL / 2,420' FEL (SE/4 SEC 24)	1443.07	1444.57
LP-1	LANDING POINT	274604	1904352	35° 45′ 14.24″ -98° 19′ 20.44″	35.753956 -98.322343	30' FNL / 2,475' FWL (NW/4 SEC 25)		-
BHL-1	BOTTOM HOLE LOCATION	264141	1904329	35° 43′ 30.75″ -98° 19′ 20.29″	35.725210 -98.322303	50' FSL / 2,475' FWL (SW/4 SEC 36)		1
W2	JALOU 2-25-36XHM	274940	1904752	35° 45' 17.57" -98° 19' 15.60"	35.754881 -98.321001	305' FSL / 2,420' FEL (SE/4 SEC 24)	1442.94	1444.57
LP-2	LANDING POINT	274605	1905189	35° 45′ 14.27" -98° 19′ 10.28"	35.753964 -98.319523	30' FNL / 1,980' FEL (NE/4 SEC 24)		
BHL-2	BOTTOM HOLE LOCATION	264141	1905150	35° 43′ 30.78″ -98° 19′ 10.34″	35.725218 -98.319539	50' FSL / 1,980' FEL (SE/4 SEC 36)		
X-1	WALKER #1-24	275298	1902540	35° 45′ 21.04″ -98° 19′ 42.45″	35.755843 -98.328459	24-15N-11W:SW4SW4   TD: 10,100'   660' FSL / 660' FWL		
X-2	LYLE CARTER #1	270683	1905835	35° 44' 35.51" -98° 19' 02.29"	35.743196 -98.317303	25-15N-11W:SE4   TD: 10,170'   1,320' FSL / 1,320' FWL		
X-3	GIGER #1-25	270680	1903199	35° 44' 35.39" -98° 19' 34.27"	35.743163 -98.326185	25-15N-11W:SW4   TD: 10,180'   1,320' FSL / 1,320' FWL		
X-4	LAIRD #1-25	272662	1906671	35° 44′ 55.10" -98° 18′ 52.23"	35.748640 -98.314509	25-15N-11W:W2E2SE4NW4   TD: 10,200'   660' FSL / 2,145' FWL		1
X-5	HELM TRUST #1-25	273142	1906508	35° 44' 59.85" -98° 18' 54.22"	35.749958 -98.315061	25-15N-11W:N2N2SE4NE4   TD: 10,100'   1,140' FSL / 1,980' FWL		
X-6	H.F. LOOKABOUGH #1	265413	1903184	35° 43′ 43.30″ -98° 19′ 34.24″	35.728694 -98.326177	36-15N-11W:SW4   TD: 10,300'   1,320' FSL / 1,320' FWL		1
X-7	H.F. LOOKABOUGH #2	265411	1904495	35° 43' 43.32" -98° 19' 18.33"	35.728699 -98.321759	36-15N-11W:S2   TD: 10,250'   1,320' FSL / 2,640' FWL		-
X-8	E. LEWIS #1	268043	1905824	35° 44′ 09.40″ -98° 19′ 02.32″	35.735943 -98.317312	36-15N-11W:NE4   TD: 10,178'   1,320' FSL / 1,320' FWL		
X-9	LOOKABOUGH #2	268032	1903197	35° 44' 09.20" -98° 19' 34.19"	35.735889 -98.326164	36-15N-11W:NW4   TD: 10,250'   1,320' FSL / 1,320' FWL		-
X-10	LOOKABOUGH #3	265413	1902964	35° 43′ 43.30″ -98° 19′ 36.91″	35.728693 -98.326918	36-15N-11W:E2E2W2SW4   TD: 10,400'   1,320' FSL / 1,100' FWL		
X-11	LEWIS #2-36	267056	1906480	35° 43′ 59.65″ -98° 18′ 54.32″	35.733237 -98.315089	36-15N-11W:S2SE4NE4   TD: 10,130'   330' FSL / 1,980' FWL		-
X-12	LOOKABOUGH 25_24-15N-11W	269115	1902113	35° 44′ 19.87" -98° 19′ 47.37"	35.738853 -98.329826	36-15N-11W:NW4NW4NW4NW4   TD: 21,890'   244' FNL / 234' FWL		
X-13	MOWERY #1-36H	269110	1902954	35° 44' 19.85" -98° 19' 37.17"	35.738847 -98.326992	36-15N-11W:NE4NE4NW4NW4   TD: 16,259'   250' FNL / 1,075' FWL		

Certificate of Authorization No. 7318

Date Staked: 02-20-18 Date Drawn: 02-20-18



Prepared By: Petro Land Services South 10400 Vineyard Blvd. Suite C Oklahoma City, OK 73120

R E	REVISIONS							
No.	DATE	BY	DESCRIPTION	COMMENTS				
00	02-20-18	MJL	ISSUED FOR APPROVAL					

PETRO LAND SERVICES SOUTH, L
10400 VINEYARD BLVD. SUITE C, OKLA. CITY, OKLA. 73120 \* OFFICE (405) 212-3108
Certificate of Authorization No. 7318



CONTINENTAL RESOURCES, INC (OPERATOR)

**EXHIBIT:** A (3 of 4) 8.5x14 SHFFT: 24-15N-11W SHL:


BHL-1:

36-15N-11W

**BLAINE** County Oklahoma 335' FSL-2420' FEL Section  $\frac{24}{100}$  Township  $\frac{15}{100}$  Range  $\frac{11}{100}$  I.M.

011-23970

WELL: JALOU 1-25-36XHM

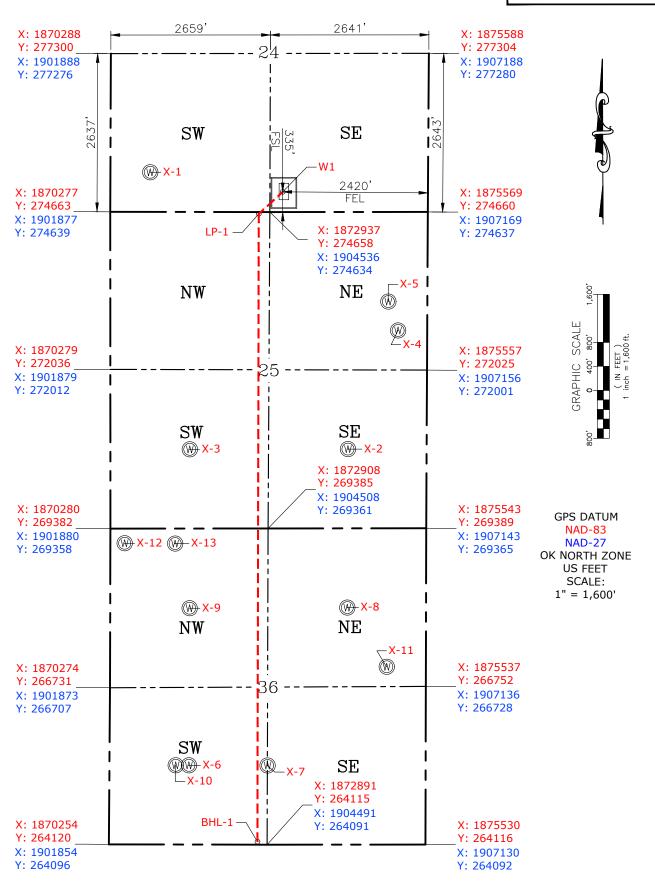

Please note that this location was staked on the ground under the supervision of a Licensed Professional Land Surveyor, but the accuracy of this survey is not guaranteed. Please contact PLS promptly if any inconsistency is determined. GPS data is observed from RTK-GPS. NOTE: X and Y data shown hereon for Section Corners may NOT have been surveyed on-the-ground, and further, does NOT represent a true Boundary Survey. Quarter Section distances may be assumed from a Government Survey Plat or assumed at a proportionate distance from opposing section corners, or occupation thereof, and may not have been measured on-the-ground, and further, does not represent a true Boundary Survey.

# CERTIFICATE:

I, RANDALL J. BILYEU an Oklahoma Licensed Land Surveyor and an authorized agent of Petro Land Services South, LLC, do hereby certify to the information shown herein.

Date Staked: 02-20-18 Date Drawn: 02-20-18



Oklahoma PLS No.1196

DATE

PETRO LAND SERVICES SOUTH, L
10400 VINEYARD BLVD. SUITE C, OKLA. CITY, OKLA. 73120 \* OFFICE (405) 212-3108
Certificate of Authorization No. 7318



CONTINENTAL RESOURCES, INC (OPERATOR)

JALOU 2-25-36XHM

8.5x14 SHFFT: 24-15N-11W

EXHIBIT: <u>A (4 of 4)</u>

SHL: 36-15N-11W BHL-2:

**BLAINE** County Oklahoma 305' FSL-2420' FEL Section  $\frac{15N}{15}$  Range  $\frac{11W}{1}$  I.M. 24 Township \_

011-23971 WELL:

2659 2641 X: 1875588 Y: 277304 X: 1870288 Y: 277300  $2^{1}4$ X: 1901888 X: 1907188 Y: 277276 Y: 277280 2637, SW SE <u>305</u> <u>FSL</u> IP-2 **₩-X-1** X: 1870277 W2 X: 1875569 Y: 274663 Y: 274660 X: 1901877 X: 1907169 X: 1872937 Y: 274639 Y: 274637 Y: 274658 X: 1904536 Y: 274634 NW NE **(M)** SCAL X: 1870279 X: 1875557 GRAPHIC Y: 272036 Y: 272025 25 X: 1901879 X: 1907156 Y: 272012 Y: 272001 , 00-SW SE **₩X-3** ₩-X-2 X: 1872908 Y: 269385 X: 1904508 Y: 269361 X: 1870280 X: 1875543 **GPS DATUM** Y: 269382 Y: 269389 NAD-83 X: 1901880 X: 1907143 ₩ X-12 ₩-X-13 NAD-27 Y: 269358 Y: 269365 OK NORTH ZONE **US FEET** SCALE: 1" = 1,600' **₩ X-9 ₩-X-8** NE NW X-11 **®** X: 1875537 X: 1870274 Y: 266731 Y: 266752 36 X: 1901873 X: 1907136 Y: 266707 Y: 266728 SW (W) ₩₩-X-6 SEX-10 X: 1872891 Y: 264115 X: 1904491 X: 1870254 X: 1875530 Y: 264091 Y: 264120 Y: 264116 X: 1901854 X: 1907130 Y: 264096 Y: 264092 -BHL-2

Please note that this location was staked on the ground under the supervision of a Licensed Professional Land Surveyor, but the accuracy of this survey is not guaranteed. Please contact PLS promptly if any inconsistency is determined. GPS data is observed from RTK-GPS. NOTE: X and Y data shown hereon for Section Corners may NOT have been surveyed on-the-ground, and further, does NOT represent a true Boundary Survey. Quarter Section distances may be assumed from a Government Survey Plat or assumed at a proportionate distance from opposing section corners, or occupation thereof, and may not have been measured on-the-ground, and further, does not represent a true Boundary Survey.

#### CERTIFICATE:

I, RANDALL J. BILYEU an Oklahoma Licensed Land Surveyor and an authorized agent of Petro Land Services South, LLC, do hereby certify to the information shown herein.

Date Staked: 02-20-18 Date Drawn: 02-20-18



DATE

В EXHIBIT: \_

SHEET:

BHL-2:

PETRO LAND SERVICES SOUTH, LLC

10400 VINEYARD BLVD. SUITE C, OKLA. CITY, OKLA. 73120 \* OFFICE (405) 212-3108 Certificate of Authorization No. 7318

Continental

CONTINENTAL RESOURCES, INC (OPERATOR)

24-15N-11W SHL:

8.5x11

36-15N-11W BHL-1: 36-15N-11W W1:335' FSL-2420' FEL

BLAINE \_ County Oklahoma  $\underline{\text{W2:}305' \text{ FSL-}2420' \text{ FEL}}$  Section  $\underline{24}$  Township  $\underline{15N}$  Range  $\underline{11W}$  I.M.

400' GRAPHIC SCALE 100 ( IN FEET ) 1 inch = 100 ft. 00 00 00 LEVEL AREA 00 275'x160'  $(\mathbf{S})(\mathbf{S})$ **W1 E**E 120' 120' 60 100 ⊖ੜੱ **W**2 O 并 00 25 METER PROPOSED PAD 4.50 ACRES RUN THIS POINT 75' FSL ACCESS 400' 2,198' FEL

W1: JALOU 1-25-36XHM DATUM: NAD-83

35°45'18.03" LAT: LONG: <u>-98°19'16.84"</u>

LAT: 35.755008°

<u>-98.321345°</u> LONG:

STATE PLANE **COORDINATES** 

(US FEET): OK NORTH

X: <u>1873152</u> Υ: 274994

W2: JALOU 2-25-36XHM

DATUM: NAD-83

35°45'17.73" LAT: LONG: <u>-98°19'16.84"</u>

LAT: 35.754926°

<u>-98.321345°</u> LONG:

STATE PLANE COORDINATES (US FEET): OK NORTH

X: <u>1873152</u> 274964 Y:

Operator: CONTINENTAL RESOURCES, INC.

Lease Name: \_\_\_

Topography & Vegetation: Pasture Good Drill Site?

Reference Stakes or Alternate Location Stakes Set: Best Accessibility to Location:  $\underline{\mathsf{Fro}}^{\mathsf{m}}$  The South Line

Distance & Direction From Hwy. or Town: Starting from the Intersection of SH-3 & N-2610 Rd.. Head south for 6 miles & turn left. Head east on E-0870 for 1.56 miles to the proposed access road located along the north side of E-0870 Rd..

THE INFORMATION SHOWN HEREIN IS FOR CONSTRUCTION **PURPOSES ONLY** 

JALOU 1-25-36XHM Well W1: \_ JALOU 2-25-36XHM Well W2: .

This Information Was Gathered With a GPS Receiver With ±1 Foot Horiz./Vert. Accuracy

LANDING POINT, BOTTOM HOLE AND DRILL PATH INFORMATION PROVIDED BY OPERATOR LISTED. NOT SURVEYED.




Prepared By: Petro Land Services South 10400 Vineyard Blvd. Oklahoma City, OK 73120

EXHIBIT: \_\_\_\_\_\_C SHEET: \_\_\_\_\_8.5×11


SHL: 24-15N-11W BHL-1: 36-15N-11W

BHL-1: 36-15N-11W



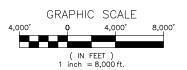

# VICINITY MAP

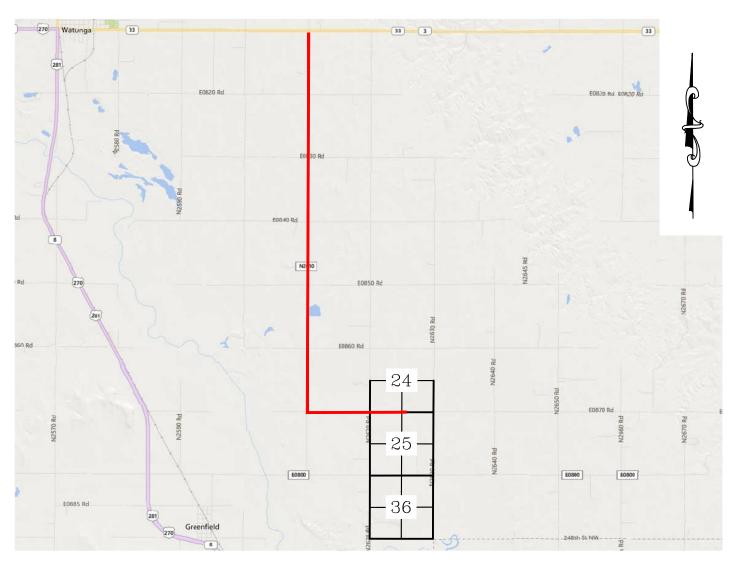

STARTING FROM THE INTERSECTION OF SH-3 & N-2610 RD.. HEAD SOUTH FOR 6 MILES & TURN LEFT. HEAD EAST ON E-0870 FOR 1.56 MILES TO THE PROPOSED ACCESS ROAD LOCATED ALONG THE NORTH SIDE OF E-0870 RD..

### CONTINENTAL RESOURCES, INC.

P.O. BOX 26900 OKLAHOMA CITY, OK 73126 \* (T) 1-800-256-8955 (F) 405-234-9253

 Certificate of Authorization No. 7318
 Section
 24 Township
 15N Range
 Range
 11W I.M.
 Well W1:
 JALOU 1-25-36XHM

 Date Staked: 02-20-18
 County
 BLAINE
 State
 OK
 Well W2:
 JALOU 2-25-36XHM

CONTINENTAL RESOURCES, INC.



Prepared By: Operator
Petro Land Services South
10400 Vineyard Blvd.
Suite C
Oklahoma City, OK 73120

EXHIBIT: \_\_\_\_D

SHEET: 8.5x11

SHL:  $\frac{24-15N-11W}{36-15N-11W}$ BHL-1:  $\frac{36-15N-11W}{36-15N-11W}$ 



WELL W1: JALOU 1-25-36XHM
WELL W2: JALOU 2-25-36XHM

#### FACING NORTH



JALOU 1-25-36XHM



JALOU 2-25-36XHM

#### FACING SOUTH



JALOU 1-25-36XHM



JALOU 2-25-36XHM



Prepared By: Petro Land Services South 10400 Vineyard Blvd. Suite C Oklahoma City, OK 73120

TERRAIN

DRAWN BY:	MJL	SCALE:	N.T.S.
CHECKED BY:	MVA	JOB No.:	
APPROVED BY:		DWG. NO.:	TERRAIN-1
DATE ISSUED:	02-20-18	SHEET:	1 OF 2

EXHIBIT: \_\_\_E

SHEET: 8.5x11

SHL:  $\frac{24-15N-11W}{36-15N-11W}$ BHL-1:  $\frac{36-15N-11W}{36-15N-11W}$ 



WELL W1: JALOU 1-25-36XHM
WELL W2: JALOU 2-25-36XHM

#### FACING EAST



JALOU 1-25-36XHM



JALOU 2-25-36XHM

### FACING WEST



JALOU 1-25-36XHM



JALOU 2-25-36XHM



Prepared By: Petro Land Services South 10400 Vineyard Blvd. Suite C Oklahoma City, OK 73120

TERRAIN

DRAWN BY:	MJL	SCALE:	N.T.S.
CHECKED BY:	MVA	JOB No.:	
APPROVED BY:		DWG. NO.:	TERRAIN-2
DATE ISSUED:	02-20-18	SHEET:	2 OF 2

EXHIBIT: \_\_\_\_\_

SHL:

SHEET: \_\_\_\_8.5x11 24-15N-11W

BHL-1: 36-15N-11W BHL-2: 36-15N-11W



JALOU 1-25-36XHM WELL W1:\_ JALOU 2-25-36XHM WELL W2:\_


PROPOSED ACCESS ROAD = 75' | 4.55 RODS (TOTAL)



 $\frac{24}{100}$  Township  $\frac{15}{100}$  Range  $\frac{11}{100}$  I.M.

BLAINE State

CONTINENTAL RESOURCES, INC.

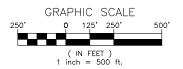




Prepared By: Petro Land Services South 10400 Vineyard Blvd. Suite C Oklahoma City, OK 73120

AERIAL PLAT

DRAWN BY:	MJL	SCALE:	1" = 500'
CHECKED BY:	MVA	JOB No.:	
APPROVED BY:		DWG. NO.:	AERIAL—1
DATE ISSUED:	02-20-18	SHEET:	1 OF 4

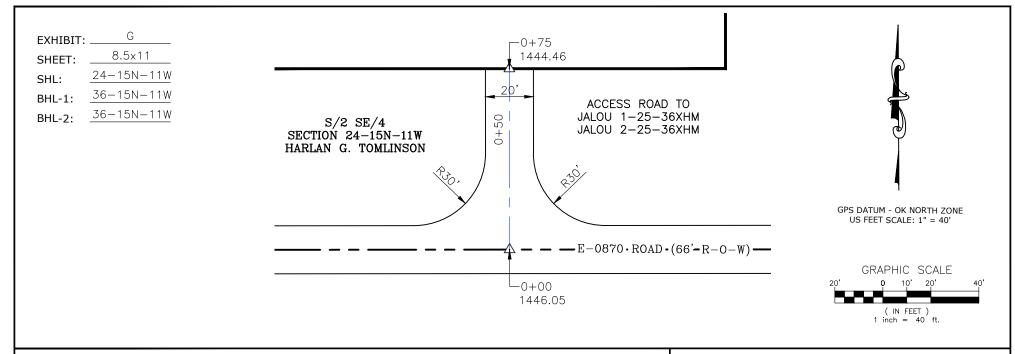


 THIS PROPOSED LEASE ROAD PLAT DOES NOT REPRESENT A TRUE Well W1:\_ BOUNDARY SURVEY.


Well W1: JALOU 1-25-36XHM

PROPOSED ACCESS ROAD = 75' | 4.55 RODS (TOTAL)

THE FOOTAGES AND TIES SHOWN HEREON ARE FROM LINES OF OCCUPATION AND MAY NOT BE FROM ACTUAL PROPERTY CORNERS.

Well W2: JALOU 2-25-36XHM

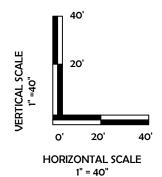

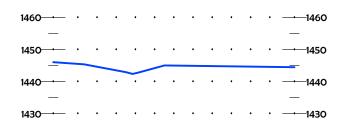



Services South ord Blvd.

ty, OK 73120

Continental

P.O Box 26900 Oklahoma City Oklahoma, 73126 (T) 1-800-256-8955 (F) 405-234-9253 LEASE ROAD PLAN & PROFILE

DRAWN BY:	MJL	SCALE:	AS NOTED
CHECKED BY:	MVA	JOB No.:	
APPROVED BY:		DWG. NO.:	P&P
DATE ISSUED:	02-20-18	SHEET:	2 OF 4

EXHIBIT: H


SHEET: 8.5x11

SHL: 24-15N-11W BHL-1: 36-15N-11W

BHL-2: 36-15N-11W



WELL W1: JALOU 1-25-36XHM
WELL W2: JALOU 2-25-36XHM

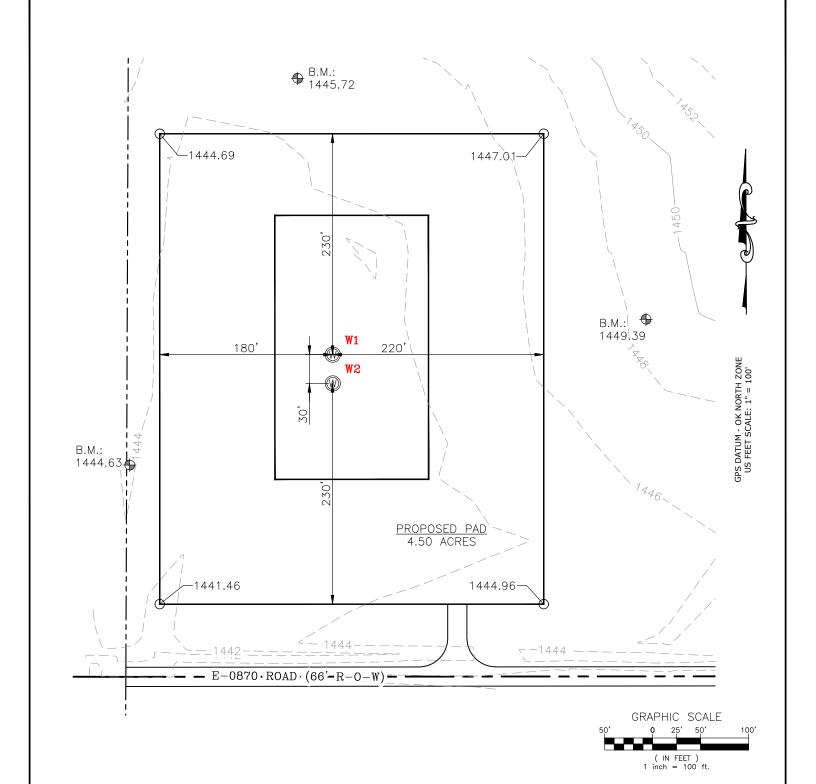



Prepared By: Petro Land Services South 10400 Vineyard Blvd. Suite C Oklahoma City, OK 73120 EXISTING GRADING PLAN

DRAWN BY:	MJL	SCALE:	1" = 100'
CHECKED BY:	MVA	JOB No.:	
APPROVED BY:		DWG. NO.:	EX-GR.
DATE ISSUED:	02-20-18	SHEET:	3 OF 4

EXHIBIT: \_ 8.5x11 SHEET:


24-15N-11W SHL: 36-15N-11W BHL-1: 36-15N-11W

BHL-2:




JALOU 1-25-36XHM WELL W1: JALOU 2-25-36XHM WELL W2:

### TOTAL PROPOSED DISTURBED AREA: 5.44 ACRES

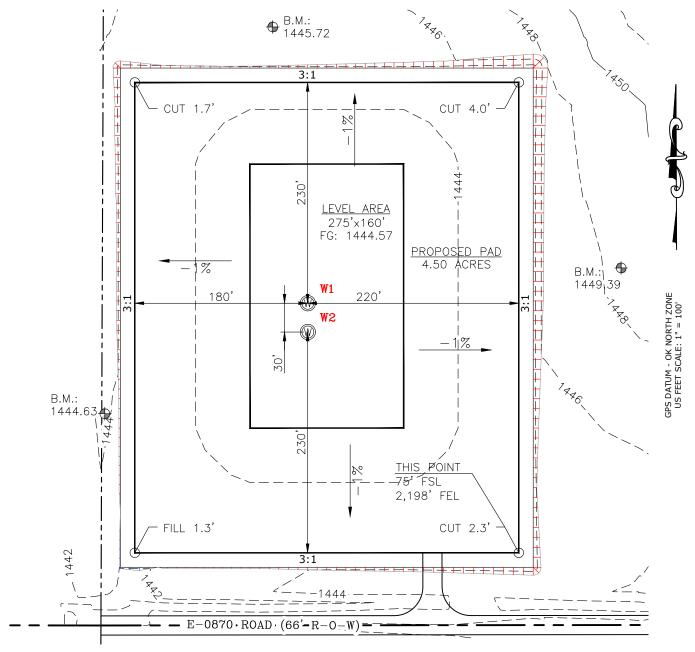

CUT VOLUME 4814.34 CU. YD. STRIP 6" TOP SOIL 3,629.63 CU. YD. FILL VOLUME 4810.40 CU. YD. BERM LENGTH:

(CUT/FILL CALCS & PROPOSED ELEVATION DOES NOT INCLUDE 6" TOP SOIL STRIP)

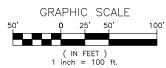



Prepared By: Petro Land Services South 10400 Vineyard Blvd. Oklahoma City, OK 73120

PROPOSED GRADING PLAN

DRAWN BY:	MJL	SCALE:	1" = 100'
CHECKED BY:	MVA	JOB No.:	
APPROVED BY:		DWG. NO.:	PRO-GR.
DATE ISSUED:	02-20-18	SHEET:	4 OF 4

EXHIBIT: A (1 of 4)

SHEET: 8.5x11

SHL:

24-15N-11W

BHL;

36-15N-11W



# COVER SHEET

# CONTINENTAL RESOURCES, INC. P.O. BOX 26900 OKLAHOMA CITY, OK 73126 \* (T) 1-800-256-8955 (F) 405-234-9253

Section	24 Township	15N Range	<u>_11W</u> _1.M.	Well: _	JALOU 1-25-36XHM	<u>01</u> 1-23970
County	BLAINE	State	ок	\A/a∏ -	JALOU 2-25-36XHM	011-2397

Operator CONTINENTAL RESOURCES, INC.

						1		
		NAD-	-83					
POINT	WELL NAME	NORTHING	EASTING	LATITUDE LONGITUDE	LATITUDE LONGITUDE			EXISTING ELEVATION
₩1	JALOU 1-25-36XHM	275680	1873224	35' 45' 24.82" -98' 19' 18.00"	35.756894 -98.321110		1022' FSL / 2,352' FEL (SE/4 SEC 24)	1022' FSL / 2,352' FEL (SE/4 SEC 24) 1457.62
LP−1	LANDING POINT	274628	1872752	35' 45' 14.40" -98' 19' 21.58"	35.754001 -98.322688		30' FNL / 2,475' FWL (NW/4 SEC 25)	30' FNL / 2,475' FWL (NW/4 SEC 25)
BHL-1	BOTTOM HOLE LOCATION	264165	1872730	35" 43" 30.92" -98" 19" 21.53"	35.725255 -98.322647		50' FSL / 2,475' FWL (SW/4 SEC 36)	50' FSL / 2,475' FWL (SW/4 SEC 36)
<b>W</b> 2	JALOU 2-25-36XHM	275680	1873254	35° 45' 24.82" -98" 19' 15.63"	35.756895 -98.321009	١	1022' FSL / 2322' FEL (SE/4 SEC 24)	1022' FSL / 2322' FEL (SE/4 SEC 24) 1458.81
LP-2	LANDING POINT	274629	1873589	35' 45' 14.43" -98' 19' 11.52"	35.754009 -98.319867		30' FNL / 1,980' FEL (NE/4 SEC 24)	30' FNL / 1,980' FEL (NE/4 SEC 24)
BHL-2	BOTTOM HOLE LOCATION	264165	1873550	35' 43' 30.95" -98' 19' 11.58"	35.725263 -98.319863		50' FSL / 1,980' FEL (SE/4 SEC 38)	50' FSL / 1,980' FEL (SE/4 SEC 38)
X-1	WALKER ∦1-24	275322	1870940	35' 45' 21.20" -98' 19' 43.69"	35.755888 -98.328804		24-15N-11W:SW4SW4   T0: 10,100'   660' FSL / 860' FWL	
X-2	LYLE CARTER #1	270707	1874235	35° 44° 35.67° -98° 19° 03.53°	35.743242 -98.317647		25-15N-11W:SE4   TD: 10,170'   1,320' FSL / 1,320' FWL	
X-3	GIGER #1-25	270704	1871599	35° 44° 35.55″ -98° 19° 35.50″	35.743209 -98.326529		25-15N-11W:SW4   TD: 10,180'   1,320' FSL / 1,320' FWL	
X-4	LAIRD #1-25	272686	1875071	35° 44° 55.26° -98° 18° 53.47°	35.748685 -98,314852		25-15N-11W:W2E2SE4NW4   TD: 10,200'   660' FSL / 2,145' FWL	
X-5	HELM TRUST #1-25	273166	1874909	35' 45' 00.01" -98' 18' 55.46"	35.750003 -98.315405		25-15N-11W:N2N2SE4NE4   TD: 10,100'   1,140' FSL / 1,980' FWL	
X-6	H.F. LOOKABOUGH #1	265437	1871584	35° 43° 43.46″ -98° 19° 35.48″	35.728740 -98.326521		36-15N-11W:SW4   TD: 10,300'   1,320' FSL / 1,320' FWL	
X-7	H.F. LOOKABOUGH #2	265435	1872895	35' 43' 43.48" ~98' 19' 19.57"	35.728745 -98.322103		36-15N-11W:S2   TD: 10,250'   1,320' FSL / 2,640' FWL	
X-8	E. LEWIS <b>#</b> 1	268067	1874224	35' 44' 09.56" -96' 19' 03.56"	35.735989 -98.317656		36-15N-11W:NE4   TD: 10,178'   1,320' FSL / 1,320' FWL	
X-9	LOOKABOUGH #2	268056	1871597	35' 44' 09.37" -98' 19' 35.43"	35.735935 -98.326508		36-15N-11W:NW4   TD: 10,250'   1,320' FSL / 1,320' FWL	
X-10	LOOKABOUGH #3	265437	1871364	35' 43' 43.46" -98' 19' 38.14"	35.728739 -98.327262		36-15N-11W:E2E2W2SW4   TD: 10,400'   1,320' FSL / 1,100' FWL	
X-11	LEWIS #2-36	267080	1874881	35° 43° 59.82° -98° 18° 55.56°	35.733282 -98.315432	I	36-15N-11W:S2SE4NE4   TD: 10,130'   330' FSL / 1,980' FWL	
X-12	L00KAB0UGH 25_24-15N-11W	269139	1870514	35' 44' 20.04" -98' 19' 48.61"	35.738899 -98.330170		36-15N-11W:NW4NW4NW4NW4   TD: 21,890'   244' FNL / 234' FWL	
X-13	MOWERY ∯1-36H	269134	1871355	35° 44° 20.01″ -96° 19° 38.41″	35.738893 -98.327336	Ì	36-15N-11W:NE4NE4NW4NW4   TD: 16,259'   250' FNL / 1,075' FWL	

Certificate of Authorization No. 7318

Date Staked: 02-20-18 Date Drawn: 02-20-18



Prepared By: Petro Lond Services South 10400 Vineyard Blvd. Suite C Oklahoma City, OK 73120

REVISIONS									
No.	DATE	ВҮ	DESCRIPTION	COMMENTS					
00	02-20-18	MJL	ISSUED FOR APPROVAL	_					
01	02-23-18	MJL	ADDED WEST ACCESS RD.	REV. EXHIBITS: B, F, G, H & I					
02	03-30-18	MJL	REV. PAD LOCATION (NORTH)	REV. ALL SHEETS					
				·					

EXHIBIT: A (2 of 4)

SHEET: 8.5x11

SHL:

24-15N-11W

BHL:

36-15N-11W



# COVER SHEET

### CONTINENTAL RESOURCES, INC.

P.O. BOX 26900 OKLAHOMA CITY, OK 73126 \* (T) 1-800-256-8955 (F) 405-234-9253

Section 24 Township 15N Range 11W I,M.

Well: \_\_\_\_JALOU 1-25-36XHM

\_\_\_\_State \_\_\_\_OK\_\_\_\_ BLAINE County \_

Well: \_\_\_\_JALOU 2-25-36XHM

Operator CONTINENTAL RESOURCES, INC.

	NAD-27							
POINT	WELL NAME	NORTHING	EASTING	LATITUDE LONGITUDE	LATITUDE LONGITUDE		EXISTING ELEVATION	DESIGN ELEVATION
W1	JALOU 1-25-36XHM	275656	1904824	35' 45' 24.66" -98' 19' 14.76"	35,756849 -98,320766	1022' FSL / 2352' FEL (SE/4 SEC 24)	1457.62	1460.96
LP-1	LANDING POINT	274604	1904352	35' 45' 14.24" -98' 19' 20.44"	35.753956 -98.322343	30' FNL / 2,475' FWL (NW/4 SEC 25)	-	
8HL-1	BOTTOM HOLE LOCATION	264141	1904329	35' 43' 30.75" -98' 19' 20.29"	35.725210 -98.322303	50' FSL / 2,475' FWL (SW/4 SEC 36)		
W2	JALOU 2-25-36XHM	275656	1904854	35' 45' 24.66" -98' 19' 14.39"	35.756850 -98.320665	1022' FSL / 2322' FEL (SE/4 SEC 24)	1458.81	1460.96
LP−2	LANDING POINT	274605	1905189	35' 45' 14.27" -98' 19' 10.28"	35.753964 -98.319523	30' FNL / 1,980' FEL (NE/4 SEC 24)		
BHL-2	BOTTOM HOLE LOCATION	264141	1905150	35° 43° 30.78° -98° 19° 10.34°	35.725218 -98.319539	50' FSL / 1,980' FEL (SE/4 SEC 36)		
X-1	WALKER #1−24	275298	1902540	35' 45' 21.04" -98' 19' 42.45	35.755843 -98.328459	24-15N-11W:SW4SW4   TD: 10,100'   680' FSL / 660' FWL		
x-2	LYLE CARTER #1	270683	1905835	35' 44' 35.51" -98' 19' 02.29	35.743196 -98,317303	25-15N-11W:SE4   TD: 10,170'   1,320' FSL / 1,320' FWL		
x-3	GIGER #1-25	270680	1903199	35' 44' 35.39" -98' 19' 34.27"	35.743163 -98.326185	25-15N-11W:\$W4   TD: 10,180'   1,320' FSL / 1,320' FWL	<b></b> ,	
X-4	LAIRD #1~25	272662	1906671	35° 44′ 55.10° -98° 18′ 52,23°	35.748640 -98.314509	25-15N-11W:W2E2SE4NW4   TD: 10,200'   660' FSL / 2,145' FWL		
X-5	HELM TRUST #1-25	273142	1906508	35' 44' 59.85" -98' 18' 54.22"	35.749958 -98.315061	25-15N-11W:N2N2SE4NE4   TD: 10,100'   1,140' FSL / 1,980' FWL		
X-6	H.F. LOOKABOUGH #1	265413	1903184	35 43 43.30° -98 19 34.24"	35.728694 -98,326177	36-15N-11W:SW4   TD: 10,300'   1,320' FSL / 1,320' FWL		
X-7	H.F. LOOKABOUGH #2	265411	1904495	35° 43' 43.32" -98° 19° 18.33"	35.728699 -98.321759	36-15N-11W:S2   TD: 10,250'   1,320' FSL / 2,640' FWL		
х-в	E. LEWIS #1	268043	1905824	35° 44' 09.40" -98° 19' 02.32"	35.735943 -98.317312	36-15N-11W:NE4   TD: 10,178'   1,320' FSL / 1,320' FWL		
X-9	LOOKABOUGH #2	268032	1903197	35' 44' 09.20" -98' 19' 34.19"	35.735889 -98.326164	36-15N-11W:NW4   TD: 10,250'   1,320' FSL / 1,320' FWL		
X-10	LOOKABOUGH #3	265413	1902964	35' 43' 43.30" -98' 19' 36.91"	35.728693 -98.326918	36-15N-11W:E2E2W25W4   TD: 10,400'   1,320' FSL / 1,100' FWL		
X-11	LEWIS #2-36	267056	1908480	35' 43' 59.65" ~98' 18' 54.32"	35.733237 -98.315089	36-15N-11W:S2SE4NE4   TD: 10,130'   330' FSL / 1,980' FWL		
X-12	LOOKABOUGH 25_24-15N-11W	269115	1902113	35' 44' 19.87" -98' 19' 47.37"	35.738853 -98.329826	36-15N-11W:NW4NW4NW4NW4   TD: 21,890'   244' FNL / 234' FWL		
X-13	MOWERY #1-36H	269110	1902954	35' 44' 19.85" -98' 19' 37.17	35.738847 -98.326992	36-15N-11W:NE4NE4NW4NW4   TD: 16,259'   250' FNL / 1,075' FWL		

Certificate of Authorization No. 7318

Date Staked: 02-20-18 Date Drawn: 02-20-18



Prepared By: Petro Land Services South 10400 Vineyard Blvd. Suite C Oklahoma City, OK 73120

#### PETRO LAND SERVICES SOUTH, LLC

10400 VINEYARD BLVD. SUITE C, OKLA. CITY, OKLA. 73120 \* OFFICE (405) 212-3108 Certificate of Authorization No. 7318

EXHIBIT: A (3 of 4)

SHEET: 8.5x14


SHL: 24-15N-11W BHL-1: 36-15N-11W BLAINE County Oklahoma

1022' FSL-2352' FEL Section 24 Township 15N Range 11W I.M.



CONTINENTAL RESOURCES,INC (OPERATOR)

WELL: JALOU 1-25-36XHM

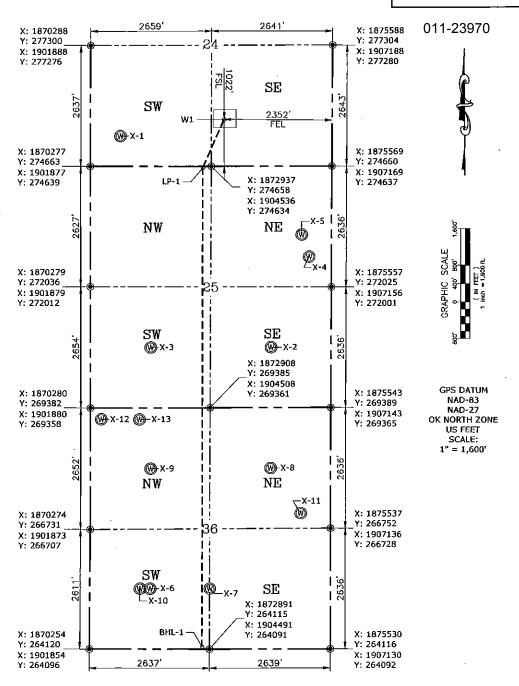

REV-2: 03-30-18
Date Staked: 02-20-18
Date Drawn: 02-20-18

Please note that this location was staked on the ground under the supervision of a Licensed Professional Land Surveyor, but the accuracy of this survey is not guaranteed. Please contact PLS promptly if any inconsistency is determined. GPS data is observed from RTK-GPS. NOTE: X and Y data shown hereon for Section Corners may NOT have been surveyed on-the-ground, and further, does NOT represent a true Boundary Survey. Quarter Section distances may be assumed from a Government Survey Plat or assumed at a proportionate distance from opposing section corners, or occupation thereof, and may not have been measured on-the-ground, and further, does not represent a true Boundary Survey.

#### CERTIFICATE:

I, RANDALL J. BILYEU an Oklahoma Licensed Land Surveyor and an authorized agent of Petro Land Services South, LLC, do hereby certify to the Information shown herein.



#### PETRO LAND SERVICES SOUTH, LLC

10400 VINEYARD BLVD. SUITE C, OKLA. CITY, OKLA. 73120 \* OFFICE (405) 212-3108 Certificate of Authorization No. 7318

EXHIBIT: A (4 of 4)

SHEET: 8.5x14

SHL:

BHL-2:


8.5x14 24-15N-11W 36-15N-11W

BLAINE \_\_\_\_\_ County Oklahoma 1022' FSL-2322' FEL Section \_\_\_\_ 24 \_\_\_ Township \_\_\_\_ 15N \_\_ Range \_\_\_ 11W \_\_ I.M.



CONTINENTAL RESOURCES,INC (OPERATOR)

WELL: JALOU 2-25-36XHM

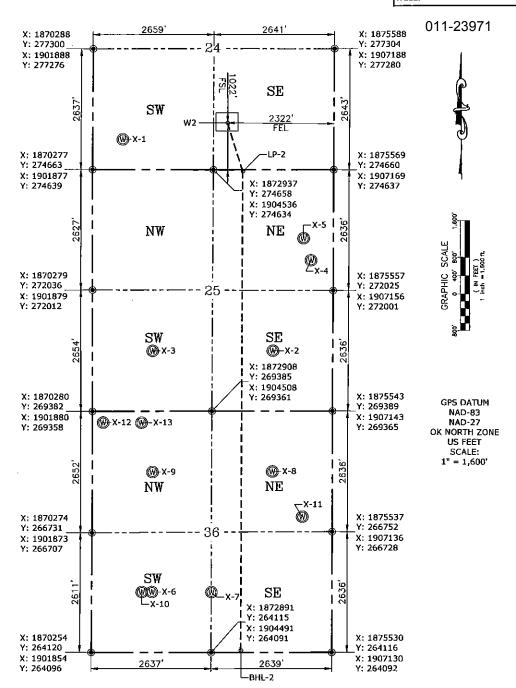

REV-2: 03-30-18

Date Slaked; 02-20-18 Dale Drawn; 02-20-18

Please note that this location was staked on the ground under the supervision of a Licensed Professional Land Surveyor, but the accuracy of this survey is not guaranteed. Please contact PLS promptly if any inconsistency is determined. GPS data is observed from RTK-GPS. NOTE: X and Y data shown hereon for Section Corners may NOT have been surveyed on-the-ground, and further, does NOT represent a true Boundary Survey. Quarter Section distances may be assumed from a Government Survey Plat or assumed at a proportionate distance from opposing section corners, or occupation thereof, and may not have been measured on-the-ground, and further, does not represent a true Boundary Survey.

#### CERTIFICATE:

I, <u>RANDALL J. BILYEU</u> an Oklahoma Licensed Land Surveyor and an authorized agent of Petro Land Services South, LLC, do hereby certify to the information shown herein.



Oklahoma PLS No.1196

DATE