API NUMBER: 011 24111

Oil & Gas

Horizontal Hole

OKLAHOMA CORPORATION COMMISSION OIL & GAS CONSERVATION DIVISION P.O. BOX 52000 OKLAHOMA CITY, OK 73152-2000 (Rule 165:10-3-1)

Approval Date: 10/19/2018
Expiration Date: 04/19/2020

PERMIT TO DRILL

WELL LOCATION: Sec: 19 Twp: 15N Rge: 10W County: BLAINE

SPOT LOCATION: SE SW SE SW FEET FROM QUARTER: FROM SOUTH FROM WEST

SECTION LINES: 230 1850

Lease Name: SCHULTE FIU Well No: 4-19-18XHM Well will be 295 feet from nearest unit or lease boundary.

Operator CONTINENTAL RESOURCES INC Telephone: 4052349020; 4052349 OTC/OCC Number: 3186 0

CONTINENTAL RESOURCES INC

PO BOX 269000

OKLAHOMA CITY, OK 73126-9000

EVA CARTER & STEPHEN CARTER, TTEES

14009 WESTBURY AVE

BAKERSFIELD CA 93314

Formation(s) (Permit Valid for Listed Formations Only):

Name Depth Name Depth MISSISSIPPIAN 1 10990 6 2 MISSISSIPPI LIME 11000 7 3 8 4 9 10 656754 Spacing Orders: Location Exception Orders: Increased Density Orders:

Pending CD Numbers: 201805460 Special Orders:

201805461 201805474 201805472

579331

Total Depth: 21605 Ground Elevation: 1465 **Surface Casing: 1500** Depth to base of Treatable Water-Bearing FM: 130

Under Federal Jurisdiction: No Fresh Water Supply Well Drilled: No Surface Water used to Drill: No

PIT 1 INFORMATION Approved Method for disposal of Drilling Fluids:

Type of Pit System: CLOSED Closed System Means Steel Pits

Type of Mud System: WATER BASED
Chlorides Max: 8000 Average: 5000

Is depth to top of ground water greater than 10ft below base of pit? Y

Within 1 mile of municipal water well? N
Wellhead Protection Area? N

Pit is located in a Hydrologically Sensitive Area.

Category of Pit: C

Liner not required for Category: C
Pit Location is AP/TE DEPOSIT
Pit Location Formation: TERRACE

D. One time land application -- (REQUIRES PERMIT) PERMIT NO: 18-35382

H. SEE MEMO

PIT 2 INFORMATION

Type of Pit System: CLOSED Closed System Means Steel Pits

Type of Mud System: OIL BASED
Chlorides Max: 300000 Average: 200000

Is depth to top of ground water greater than 10ft below base of pit? Y

Within 1 mile of municipal water well? N
Wellhead Protection Area? N

Pit is located in a Hydrologically Sensitive Area.

Category of Pit: C

Liner not required for Category: C
Pit Location is AP/TE DEPOSIT
Pit Location Formation: TERRACE

HORIZONTAL HOLE 1

Sec. 18 Twp 15N Rge 10W County **BLAINE** Spot Location of End Point: N2 NW NF NW Feet From: NORTH 1/4 Section Line: 50 WEST Feet From: 1/4 Section Line: 1650

Depth of Deviation: 10557 Radius of Turn: 477 Direction: 360

Total Length: 10299

Measured Total Depth: 21605

True Vertical Depth: 11059

End Point Location from Lease,
Unit, or Property Line: 50

Notes:

Category Description

DEEP SURFACE CASING 9/14/2018 - G71 - APPROVED; NOTIFY OCC FIELD INSPECTOR IMMEDIATELY OF ANY LOSS OF

CIRCULATION OR FAILURE TO CIRCULATE CEMENT TO SURFACE ON ANY CONDUCTOR OR

SURFACE CASING

HYDRAULIC FRACTURING 9/14/2018 - G71 - OCC 165:10-3-10 REQUIRES:

1) PRIOR TO COMMENCEMENT OF HYDRAULIC FRACTURING OPERATIONS FOR HORIZONTAL WELLS, NOTICE GIVEN FIVE BUSINESS DAYS IN ADVANCE TO OFFSET OPERATORS WITH WELLS COMPLETED IN THE SAME COMMON SOURCE OF SUPPLY WITHIN 1/2 MILE:

2) WITH NOTICE ALSO GIVEN 48 HOURS IN ADVANCE OF HYDRAULIC FRACTURING ALL WELLS TO BOTH THE OCC CENTRAL OFFICE AND LOCAL DISTRICT OFFICES, USING THE

"FRAC NOTICE FORM" FOUND AT THE FOLLOWING LINK:

OCCEWEB.COM/OG/OGFORMS.HTML; AND,

3) THE CHEMICAL DISCLOSURE OF HYDRAULIC FRACTURING INGREDIENTS FOR ALL WELLS TO BE REPORTED TO FRACFOCUS WITHIN 60 DAYS AFTER THE CONCLUSION THE HYDRAULIC FRACTURING OPERATIONS, USING THE FOLLOWING LINK: FRACFOCUS.ORG

INTERMEDIATE CASING 9/14/2018 - G71 - DUE TO THE KNOWN POTENTIAL RISK OF ENCOUNTERING AN OVER-

PRESSURED ZONE IN THE MORROW SERIES IN THIS AREA, THE TECHNICAL MANAGER RECOMMENDS SETTING AN INTERMEDIATE STRING OF CASING IMMEDIATELY ABOVE THE

MORROW SERIES

MEMO 9/14/2018 - G71 - PITS 1 & 2 - CLOSED SYSTEM=STEEL PITS PER OPERATOR REQUEST, PIT 2 -

OBM RETURNED TO VENDOR, CUTTINGS PERMITTED PER DISTRICT

Category Description

PENDING CD - 201805460 10/15/2018 - G58 - (I.O.) 18 & 19-15N-10W

X656754 MSSP 18-15N-10W

X579331 MSSLM 19-15N-10W

COMPL. INT. 19-15N-10W NCT 150' FSL, NCT 0' FNL, NCT 990' FWL COMPL. INT. 18-15N-10W NCT 0' FSL, NCT 150' FNL, NCT 990' FWL

NO OP. NAMED

REC 9/10/2018 (DENTON)

PENDING CD - 201805461 10/15/2018 - G58 - (I.O.) 18 & 19-15N-10W

EST MULTIUNIT HÖRIZONTAL WELL

X656754 MSSP 18-15N-10W X579331 MSSLM 19-15N-10W

50% 18-15N-10W 50% 19-15N-10W NO OP. NAMED

REC 9/10/2018 (DENTON)

PENDING CD - 201805472 10/15/2018 - G58 - 18-15N-10W

X656754 MSSP 7 WELLS NO OP. NAMED

REC 9/10/2018 (DENTON)

PENDING CD - 201805474 10/15/2018 - G58 - 19-15N-10W

X579331 MSSLM 7 WELLS NO OP. NAMED

REC 9/10/2018 (DENTON)

SPACING - 579331 10/15/2018 - G58 - (640) 19-15N-10W

EXT 569532/157570 MSSLM

SPACING - 656754 10/15/2018 - G58 - (640) 18-15N-10W

EXT 648028 MSSP, OTHERS

EXHIBIT: A (1 of 2) SHEET: 8.5x11 19-15N-10W SHL:

18-15N-10W BHL-4



COVER SHEET

<u>CONTINENTAL</u> <u>RESOURCES</u>, <u>INC</u>. P.O. BOX 26900 OKLAHOMA CITY, OK 73126 * (T) 1-800-256-8955 (F) 405-234-9253

011-24111

Section	$\underline{\hspace{1cm}}^{19}$ Township $\underline{\hspace{1cm}}^{15N}$	_Range _	10W_I.M.	Well:	SCHULTE FIU 4-19-18XHM
County	BLAINE	_State _	OK		
Operator	- CONTINENTAL RES	SOURCES,	INC.	Well:	

		NAD-	-83					
POINT	WELL NAME	NORTHING	EASTING	LATITUDE LONGITUDE	LATITUDE LONGITUDE		EXISTING ELEVATION	DESIGN ELEVATION
W4	SCHULTE FIU 4-19-18XHM	274897	1877421	35° 45′ 17.21″ -98° 18′ 25.05″	35.754780 -98.306957	230' FSL / 1850' FWL (SW/4 SEC 19)	1479.73'	1481.37'
LP-4	LANDING POINT	274897	1877441	35° 45' 17.21" -98° 18' 24.80"	35.754781 -98.306889	230' FSL / 1870' FWL (SW/4 SEC 19)		
BHL-4	BOTTOM HOLE LOCATION	285196	1877492	35° 46′ 59.06″ -98° 18′ 24.57″	35.783072 -98.306826	50' FNL / 1870' FWL (NW/4 SEC 18)		
X-1	STOVER UNIT #1	281444	1879326	35° 46' 22.01" -98° 18' 02.17"	35.772781 -98.300603	18-15N-10W:SE4 TD: 9,917' 1,470' FSL / 1,320' FWL		
X-2	GOODEN #1	282444	1876934	35° 46′ 31.83″ -98° 18′ 31.25″	35.775509 -98.308679	18-15N-10W:NW4NE4SW4 TD: 9,980' 2,490' FSL / 1,320' FWL		
X-3	RING #1-18	283950	1879330	35° 46′ 46.80″ -98° 18′ 02.22″	35.779667 -98.300617	18–15N–10W:NE4 TD: 9,850' 1,320' FNL / 1,320' FEL		
X-4	BONNIE STEWART UNIT #1	278634	1876917	35° 45′ 54.15″ -98° 18′ 31.30″	35.765042 -98.308695	19-15N-10W:NW4 TD: 9,927' 1,320' FSL / 1,320' FWL		
X-5	WALKER "G" #1	275994	1879328	35° 45' 28.11" -98° 18' 01.94"	35.757810 -98.300540	19-15N-10W:SE4 TD: 10,023' 1,320' FSL / 1,320' FWL		
X-6	SCHULTE #1-19H	274907	1875921	35° 45' 17.26" -98° 18' 43.24"	35.754794 -98.312012	19-15N-10W:SE4SW4SW4SW4 TD: 16,350' 245' FSL / 350' FWL		
X-7	LAWRENCE WALKER #1	275322	1876034	35° 45′ 21.37" -98° 18′ 41.89"	35.755936 -98.311636	19-15N-10W:SW4NE4 TD: 10,013' 660' FSL / 460' FWL		

		NAD-	-27					
POINT	WELL NAME	NORTHING	EASTING	LATITUDE LONGITUDE	LATITUDE LONGITUDE		EXISTING ELEVATION	DESIGN ELEVATION
W4	SCHULTE FIU 4-19-18XHM	274873	1909021	35° 45' 17.05" -98° 18' 23.81"	35.754735 -98.306614	230' FSL / 1850' FWL (SW/4 SEC 19)	1479.73'	1481.37'
LP-4	LANDING POINT	274873	1909041	35° 45' 17.05" -98° 18' 23.56"	35.754736 -98.306545	230' FSL / 1870' FWL (SW/4 SEC 19)		
BHL-4	BOTTOM HOLE LOCATION	285172	1909092	35° 46′ 58.90″ -98° 18′ 23.33″	35.783028 -98.306482	50' FNL / 1870' FWL (NW/4 SEC 18)		
X-1	STOVER UNIT #1	281420	1910926	35° 46′ 21.85″ -98° 18′ 00.93″	35.772737 -98.300260	18-15N-10W:SE4 TD: 9,917' 1,470' FSL / 1,320' FWL		
X-2	GOODEN #1	282420	1908534	35° 46′ 31.67″ -98° 18′ 30.01″	35.775465 -98.308335	18-15N-10W:NW4NE4SW4 TD: 9,980' 2,490' FSL / 1,320' FWL		
X-3	RING #1-18	283926	1910930	35° 46′ 46.64″ -98° 18′ 00.98″	35.779623 -98.300273	18-15N-10W:NE4 TD: 9,850' 1,320' FNL / 1,320' FEL		
X-4	BONNIE STEWART UNIT #1	278610	1908517	35° 45′ 53.99" -98° 18′ 30.06"	35.764997 -98.308351	19-15N-10W:NW4 TD: 9,927' 1,320' FSL / 1,320' FWL		
X-5	WALKER "G" #1	275970	1910928	35° 45' 27.95" -98° 18' 00.71"	35.757765 -98.300196	19-15N-10W:SE4 TD: 10,023' 1,320' FSL / 1,320' FWL		
X-6	SCHULTE #1-19H	274883	1907521	35° 45' 17.10" -98° 18' 42.00"	35.754749 -98.311668	19-15N-10W:SE4SW4SW4SW4 TD: 16,350' 245' FSL / 350' FWL		
X-7	LAWRENCE WALKER #1	275298	1907634	35° 45' 21.21" -98° 18' 40.65"	35.755891 -98.311292	19-15N-10W:SW4NE4 TD: 10,013' 660' FSL / 460' FWL		

Certificate of Authorization No. 7318

Date Staked: **-**-18
Date Drawn: 10-17-18



Prepared By: Petro Land Services South 10400 Vineyard Blvd. Suite C Oklahoma City, OK 73120

R	Е	٧	Ι	S	Ι	0	Ν	S
---	---	---	---	---	---	---	---	---

	KE V 13 10 N 3						
No.	DATE	BY	DESCRIPTION	COMMENTS			
00	10-17-18	HDG	ISSUED FOR APPROVAL				

EXHIBIT: A (2 of 2)

8.5x14


SHFFT: 19-15N-10W SHL: 18-15N-10W BHI -4

PETRO LAND SERVICES SOUTH, L 10400 VINEYARD BLVD. SUITE C, OKLA. CITY, OKLA. 73120 * OFFICE (405) 212-3108 Certificate of Authorization No. 7318

BLAINE County Oklahoma 230' FSL-1850' FWL Section 19 Township 15N Range 10W I.M.



CONTINENTAL RESOURCES, INC (OPERATOR)

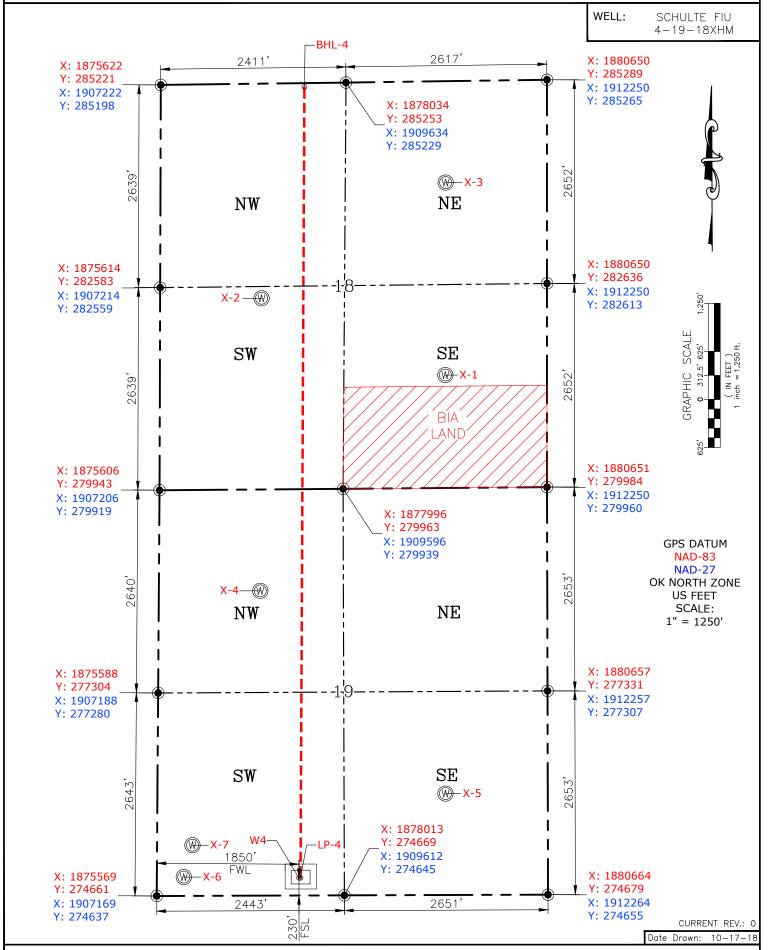

Please note that this location was staked on the ground under the supervision of a Licensed Professional Land Surveyor, but the accuracy of this survey is not guaranteed. Please contact PLS promptly if any inconsistency is determined. GPS data is observed from RTK-GPS. NOTE: X and Y data shown hereon for Section Corners may NOT have been surveyed on-the-ground, and further, does NOT represent a true Boundary Survey. Quarter Section distances may be assumed from a Government Survey Plat or assumed at a proportionate distance from opposing section corners, or occupation thereof, and may not have been measured on-the-ground, and further, does not represent a true Boundary Survey.

CERTIFICATE:

I, RANDALL J. BILYEU an Oklahoma Licensed Land Surveyor and an authorized agent of Petro Land Services South, LLC, do hereby certify to the information shown herein.



Oklahoma PLS No.1196 DATE

EXHIBIT: _

8.5x11 SHEET:

19-15N-10W SHI: 18-15N-10W BHL-4


PETRO LAND SERVICES SOUTH, LLC

10400 VINEYARD BLVD. SUITE C, OKLA. CITY, OKLA. 73120 * OFFICE (405) 212-3108 Certificate of Authorization No. 7318



CONTINENTAL RESOURCES, INC (OPERATOR)

BLAINE _ County Oklahoma 230' FSL-1850' FWL Section _ $\frac{19}{1}$ Township $\frac{15N}{1}$ Range $\frac{10W}{1}$ I.M.

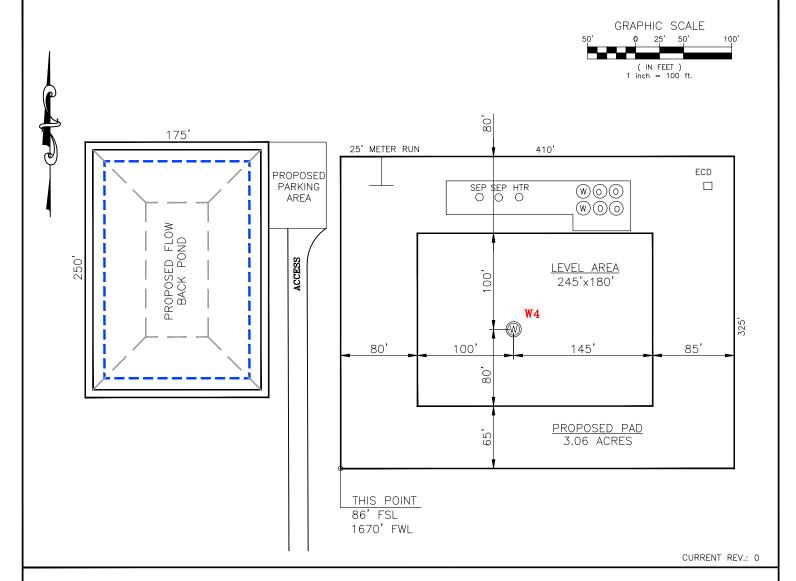

DATUM: NAD-83 <u>35°45'17.21"</u> LAT:

<u>-98°18'25.05"</u> LONG: LAT: 35.754780°

LONG: -98.306957°

STATE PLANE **COORDINATES**

(US FEET): OK NORTH

X: 1877421 274897 Y:

With a GPS Receiver With ±1 Foot Horiz./Vert. Accuracy

This Information Was Gathered

LANDING POINT, BOTTOM HOLE AND DRILL PATH INFORMATION PROVIDED BY OPERATOR LISTED, NOT SURVEYED.

CONSTRUCTION PURPOSES ONLY

THE INFORMATION SHOWN HEREIN IS FOR

Operator: CONTINENTAL RESOURCES, INC.

Lease Name: ___

Pasture Topography & Vegetation:

Good Drill Site? Yes Reference Stakes or Alternate Location Stakes Set: __

Best Accessibility to Location: From The South Line

Distance & Direction From Hwy. or Town: Leaving Watonga, head south on SH-8 for 7.43 miles. Turn left of E-0880 Rd. & head east for 4.50 miles. Turn left on N2630 Rd. & head north for 1.0 mile. Turn right on E0870 Rd & head east for

0.31 miles to the proposed access road.

Well W4: SCHULTE FIU 4-19-18XHM




Prepared By: Petro Land Services South 10400 Vineyard Blvd. Oklahoma City, OK 73120

Certificate of Authorization No. 7318


EXHIBIT: ______C
SHEET: _____8.5x11

SHL: 19-15N-10W BHL-4 18-15N-10W



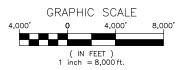

VICINITY MAP

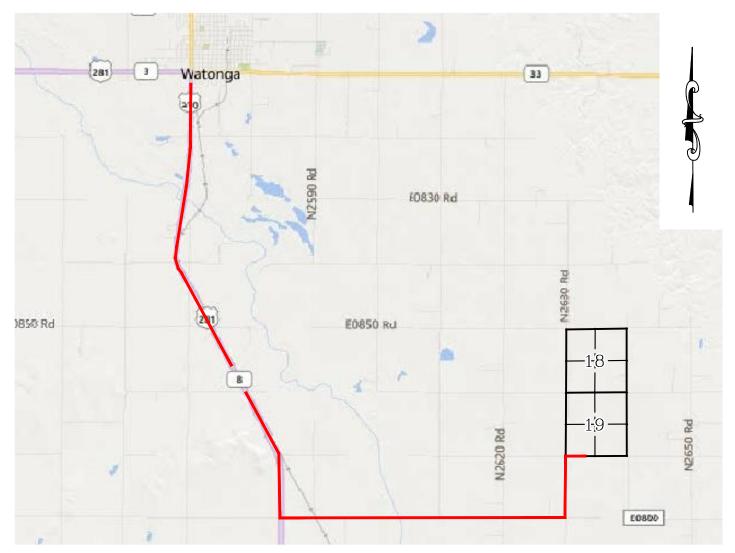

LEAVING WATONGA, HEAD SOUTH ON SH-8 FOR 7.43 MILES. TURN LEFT OF E-0880 RD. & HEAD EAST FOR 4.50 MILES. TURN LEFT ON N2630 RD. & HEAD NORTH FOR 1.0 MILE. TURN RIGHT ON E0870 RD & HEAD EAST FOR 0.31 MILES TO THE PROPOSED ACCESS ROAD.

CONTINENTAL RESOURCES, INC.

P.O. BOX 26900 OKLAHOMA CITY, OK 73126 * (T) 1-800-256-8955 (F) 405-234-9253

Certificate of Authorization No. 7318	Section _	19 Township .	15NRange .	10W_I.M.	Well W4: SCHULTE FIU 4-19-18XHM	_
	County _	BLAINE	State	OK	Well:	_

CONTINENTAL RESOURCES, INC.



Prepared By: Operator
Petro Land Services South
10400 Vineyard Blvd.
Suite C
Oklahoma City, OK 73120

EXHIBIT: _____

SHEET: 8.5×11

SHL: $\frac{19-15N-10W}{18-15N-10W}$



WELL W4: SCHULTE FIU 4-19-18XHM

FACING NORTH

(NO IMAGES AVAILABLE)

FACING SOUTH

(NO IMAGES AVAILABLE)

CURRENT REV.: 0



TERRAIN

DRAWN BY:	HDG	SCALE:	N.T.S.
CHECKED BY:	MJL	JOB No.:	
APPROVED BY:		DWG. NO.:	TERRAIN-1
DATE ISSUED:	10-17-18	SHEET:	1 OF 2

EXHIBIT: _____E

SHEET: _____8.5×11____

SHL: 19-15N-10W BHL-4 18-15N-10W



WELL W4: SCHULTE FIU 4-19-18XHM
WELL --:

FACING EAST

(NO IMAGES AVAILABLE)

FACING WEST

(NO IMAGES AVAILABLE)

CURRENT REV.: 0



Prepared By: Petro Land Services South 10400 Vineyard Blvd. Suite C Oklahoma City, OK 73120

TERRAIN

DRAWN BY:	HDG	SCALE:	N.T.S.
CHECKED BY:	MJL	JOB No.:	
APPROVED BY:		DWG. NO.:	TERRAIN-2
DATE ISSUED:	10-17-18	SHFFT:	2 OF 2

EXHIBIT: ____F


SHEET: 8.5x11

SHL: <u>19-15N-10W</u> BHL-4 <u>18-15N-10W</u>




WELL W4: SCHULTE FIU 4-19-18XHM
WELL --:

PROPOSED ACCESS ROAD = 330' | 20.00 RODS (TOTAL)

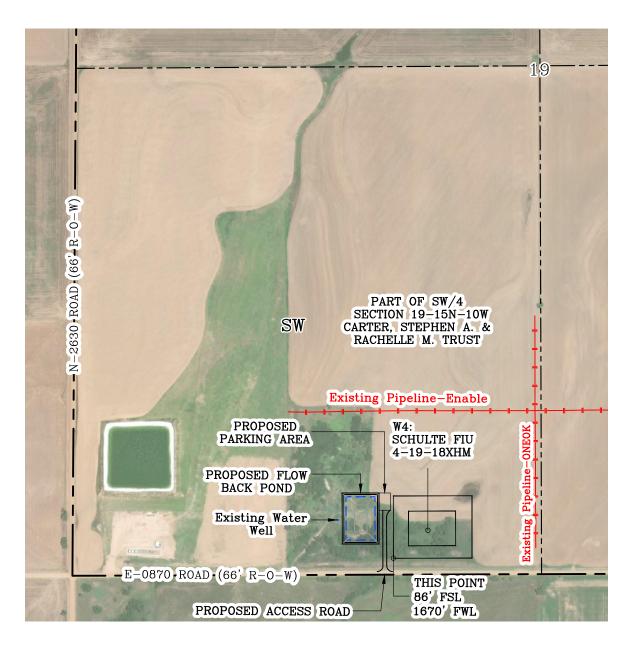

Section $\frac{19}{}$ Township $\frac{15N}{}$ Range $\frac{10W}{}$ I.M. County $\frac{}{}$ BLAINE $\frac{}{}$ State $\frac{}{}$ OK

Operator ____ CONTINENTAL RESOURCES, INC.

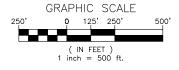

CURRENT REV.: 0

GPS DATUM - OK NORTH ZONE US FEET SCALE: 1" = 500'



Prepared By: Petro Land Services South 10400 Vineyard Blvd. Suite C Oklahoma City, OK 73120

AERIAL PLAT

DRAWN BY:	HDG	SCALE:	1" = 500'
CHECKED BY:	MJL	JOB No.:	
APPROVED BY:		DWG. NO.:	AERIAL-1
DATE ISSUED:	10-17-18	SHEET:	1 OF 4

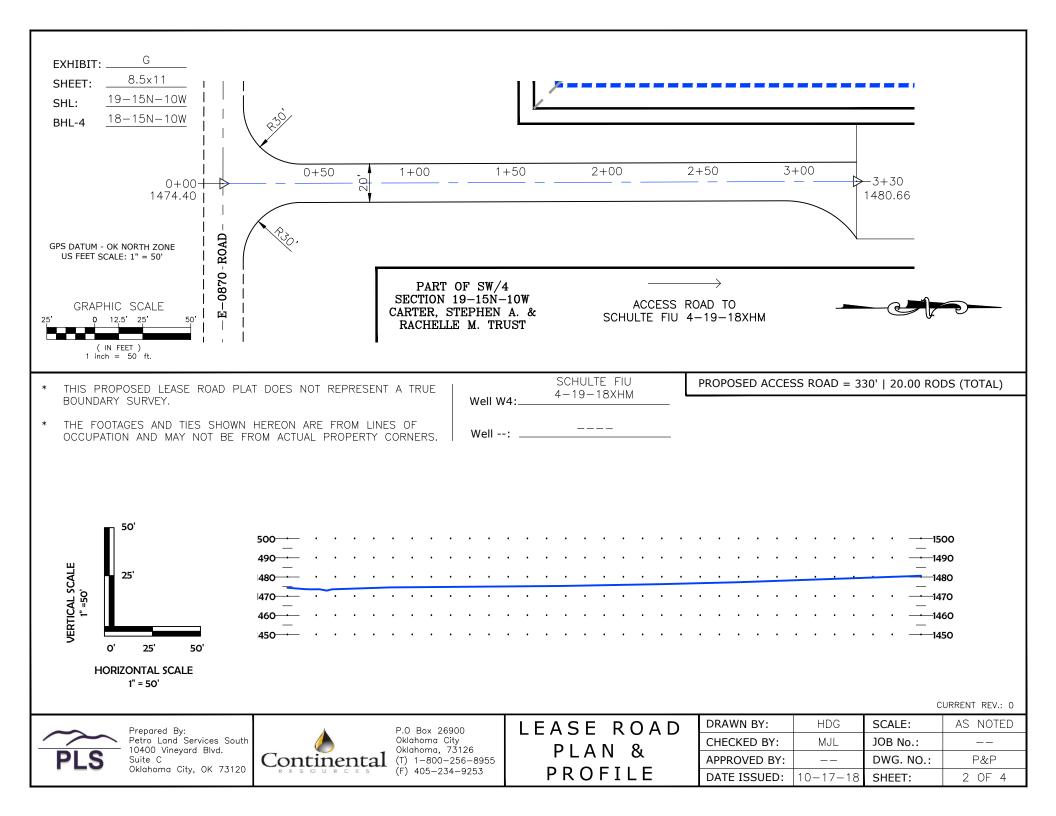


EXHIBIT: H


SHEET: 8.5x11


SHL: 19-15N-10W

BHL-4

18-15N-10W



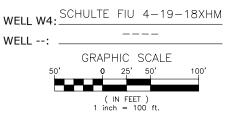

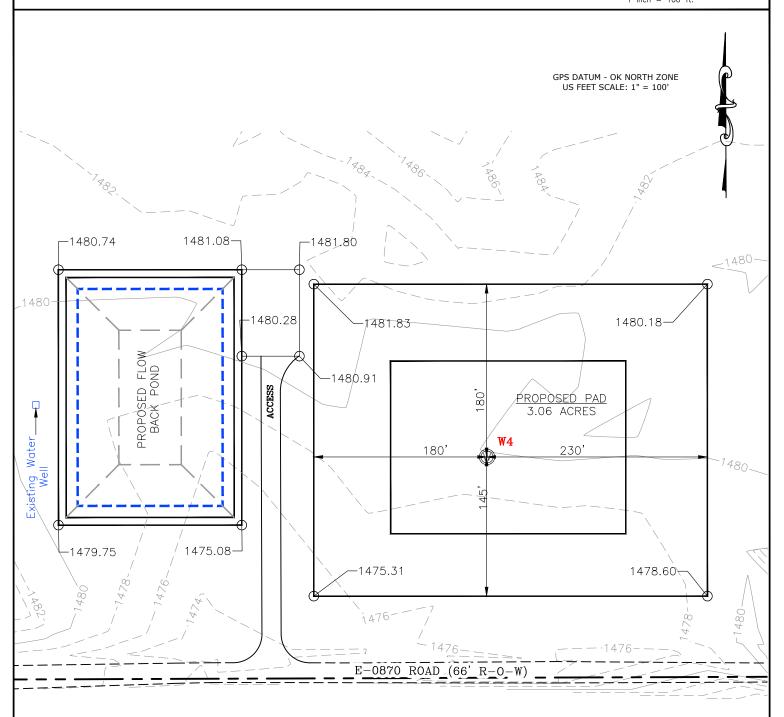

CURRENT REV.: 0




Prepared By: Petro Land Services South 10400 Vineyard Blvd. Suite C Oklahoma City, OK 73120 EXISTING GRADING PLAN

DRAWN BY:	HDG	SCALE:	1" = 100'
CHECKED BY:	MJL	JOB No.:	
APPROVED BY:		DWG. NO.:	EX-GR.
DATE ISSUED:	10-17-18	SHEET:	3 OF 4


BHL-4

18-15N-10W



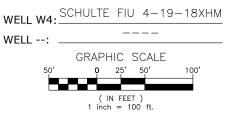

TOTAL PROPOSED DISTURBED AREA: 5.16 ACRES

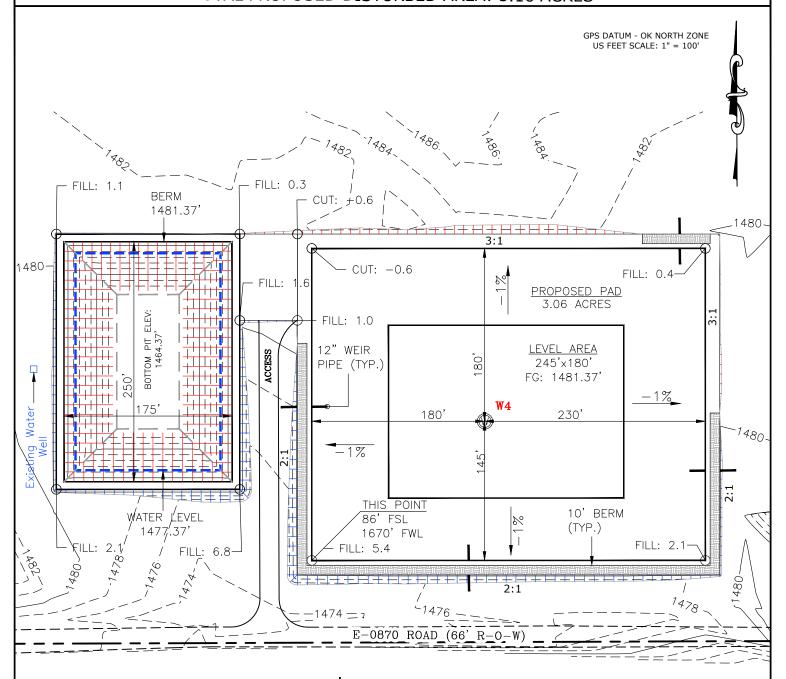

CUT VOLUME 16105.61 CU. YD. FILL VOLUME 16103.77 CU. YD.

6" OF STRIPPED TOP SOIL: 4,163.03 CU. YD. BERM LENGTH: 901' (603.67 CU. YD.)

(CUT/FILL VOLUMES INCLUDE 6" OF STRIPPED TOP SOIL)

<u>PIT DATA</u>

DIMENSIONS: 250'x175'
BERM WIDTH: 8'
BERM ELEVATION: 1481.37'

BOTTOM DIMENSIONS: 140'x65' BOTTOM ELEVATION: 1464.37' TOTAL VOLUME: 16,082.63 CU. YD. WATER LEVEL ELEVATION: 1477.37'

WATER VOLUME: 10,328.26 CU. YD.

(49,667.63 BBL's)

PIT CUT/FILL SLOPES: 3:1

CURRENT REV.: 0



Prepared By: Petro Land Services South 10400 Vineyard Blvd. Suite C Oklahoma City, OK 73120 PROPOSED GRADING PLAN

DRAWN BY:	HDG	SCALE:	1" = 100'
CHECKED BY:	MJL	JOB No.:	
APPROVED BY:		DWG. NO.:	PRO-GR.
DATE ISSUED:	10-17-18	SHEET:	4 OF 4